




- CONSTRUCTION NOTES**
- CONCRETE PAVEMENT ON GRADE. TYPICAL LIGHT BROOM FINISH. MEET EXISTING GRADES FLUSH. SEE DETAIL 1, SHEET LS-1.0.
  - SAW/CUT CONTROL JOINT, TYPICAL. PER PLANS AND DETAIL 1, SHEET LS-1.0. EXTEND COMPLETELY TO ALL VERTICAL BUILDING FACES.
  - EXPANSION JOINT, TYPICAL. SEE DETAIL 1, SHEET LS-1.0.
  - UNIT PAVEMENT, TYPE 1 ON CONCRETE BASE. TYPICAL RUNNING BOND PATTERN. MEET EXISTING GRADES FLUSH. SEE DETAIL 8, SHEET LS-1.0 AND SPEC.
  - UNIT PAVEMENT, TYPE 2 ON CONCRETE BASE. TYPICAL RUNNING BOND PATTERN. MEET EXISTING GRADES FLUSH. SEE DETAIL 8, SHEET LS-1.0 AND SPEC.
  - CONCRETE CURB AND BUTTER. TYPICAL. BUSH GRADE OF CURB TO BE AT GRADE UNLESS OTHERWISE NOTED. MEET EXISTING GRADES FLUSH.
  - ASPHALT LIFT AS REQUIRED TO MEET ADA ACCESSIBILITY REQUIREMENTS. SEE DETAILS 2 & 4, SHEET LS-4.0.
  - TRANSITION CURB FROM 8" TO FLUSH.
  - HEAVY DUTY CONCRETE PAVEMENT DRAINAGE APPROACH. MATCH EXISTING DRIVE GRADES AND LAYOUT AT LIMIT OF WORK. SEE DETAIL 3, SHEET LS-1.0.
  - TRENCH GRATE. SEE UTILITY PLAN FOR DETAILS.
  - TRAFFIC SIGNAL POLE OR PEDESTRIAN CROSSING SIGNAL. APPROXIMATE LOCATION. SEE TRAFFIC CONTROL PLAN FOR DETAILS.
  - PROPOSED FLAGPOLES. SEE DETAIL 8, SHEET LS-10.0.
  - EXISTING UTILITY VAULT.
  - RECYCLING / WASTE CONTAINER. SEE DETAIL 7, SHEET LS-10.0.
  - BIORETENTION PLANTER. SEE DETAIL 1, SHEET LS-7.0.
  - LANDSCAPE PLANTING BED. SEE PLANTING PLANS, LP SERIES.
  - EXISTING CONCRETE CURB. PROTECT IN PLACE. PROPOSED GRASSES TO MEET FLUSH.
  - EXISTING CONCRETE PAVEMENT TO REMAIN. PROTECT IN PLACE. PROPOSED GRASSES TO MEET FLUSH.
  - EXISTING FIRE HYDRANT. PROTECT IN PLACE.
  - RELOCATED FIRE HYDRANT.
  - EXISTING SIGNAL. PROTECT IN PLACE. NEW SIDEWALK TO MEET EXISTING GRADE AT TOP OF SIGNAL.
  - EXISTING SIGNAL PAVEMENT. PROTECT IN PLACE.
  - PROPOSED GRASSES TO MEET EXISTING GRADES FLUSH.
  - EXISTING CONCRETE PLANTER CURB TO REMAIN. PROTECT IN PLACE.
  - PROPOSED CONCRETE PLANTER CURB. TOP OF WALL TO MEET EXISTING GRADE. SEE DETAIL 5, SHEET LS-1.0.
  - RELOCATED HISTORIC SIGN.
  - RELOCATED WEATHER STATION POLE.
  - RELOCATED MAILBOXES.
  - GREEN SCREEN PLANTING WALL.
  - EXISTING COLLUMIN. PROTECT IN PLACE.
  - PROPOSED FLAGPOLES. SEE DETAIL 8, SHEET LS-10.0.
  - EXISTING UTILITY VAULT.
  - RECYCLING / WASTE CONTAINER. SEE DETAIL 7, SHEET LS-10.0.
  - BIKE RACK. SEE DETAIL 7, SHEET LS-10.0.
  - NEWS PACK. SEE DETAIL 5, SHEET LS-10.0.
  - FREE STANDING PLANTER. SEE DETAIL 4, SHEET LS-10.0.
  - BENCHES. SEE DETAIL 6, SHEET LS-10.0.
  - KIOSK. SEE DETAIL 6, SHEET LS-10.0.
  - TRANSIT SHELTER. SEE DETAIL 4, SHEET LS-1.0.
  - PUMP AND DISPLAY PARKING STATION. SEE DETAIL 3, SHEET LS-10.0.
  - EMBEDDED METAL BOLLARD. SEE DETAIL 1, SHEET LS-11.0.
  - REMOVABLE METAL BOLLARD. SEE DETAIL 2, SHEET LS-11.0.
  - ORNAMENTAL RAIN GARDEN FENCE. SEE DETAIL 3, SHEET LS-11.0.
  - RAIN GARDEN CURB INLET AND ORNAMENTAL GRATE. SEE DETAILS 1 & 3, SHEET LS-4.0.

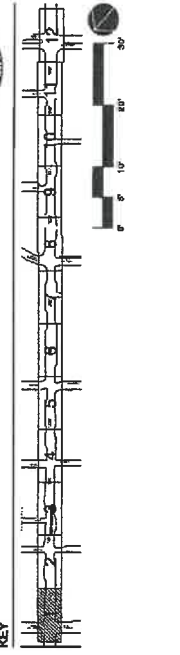


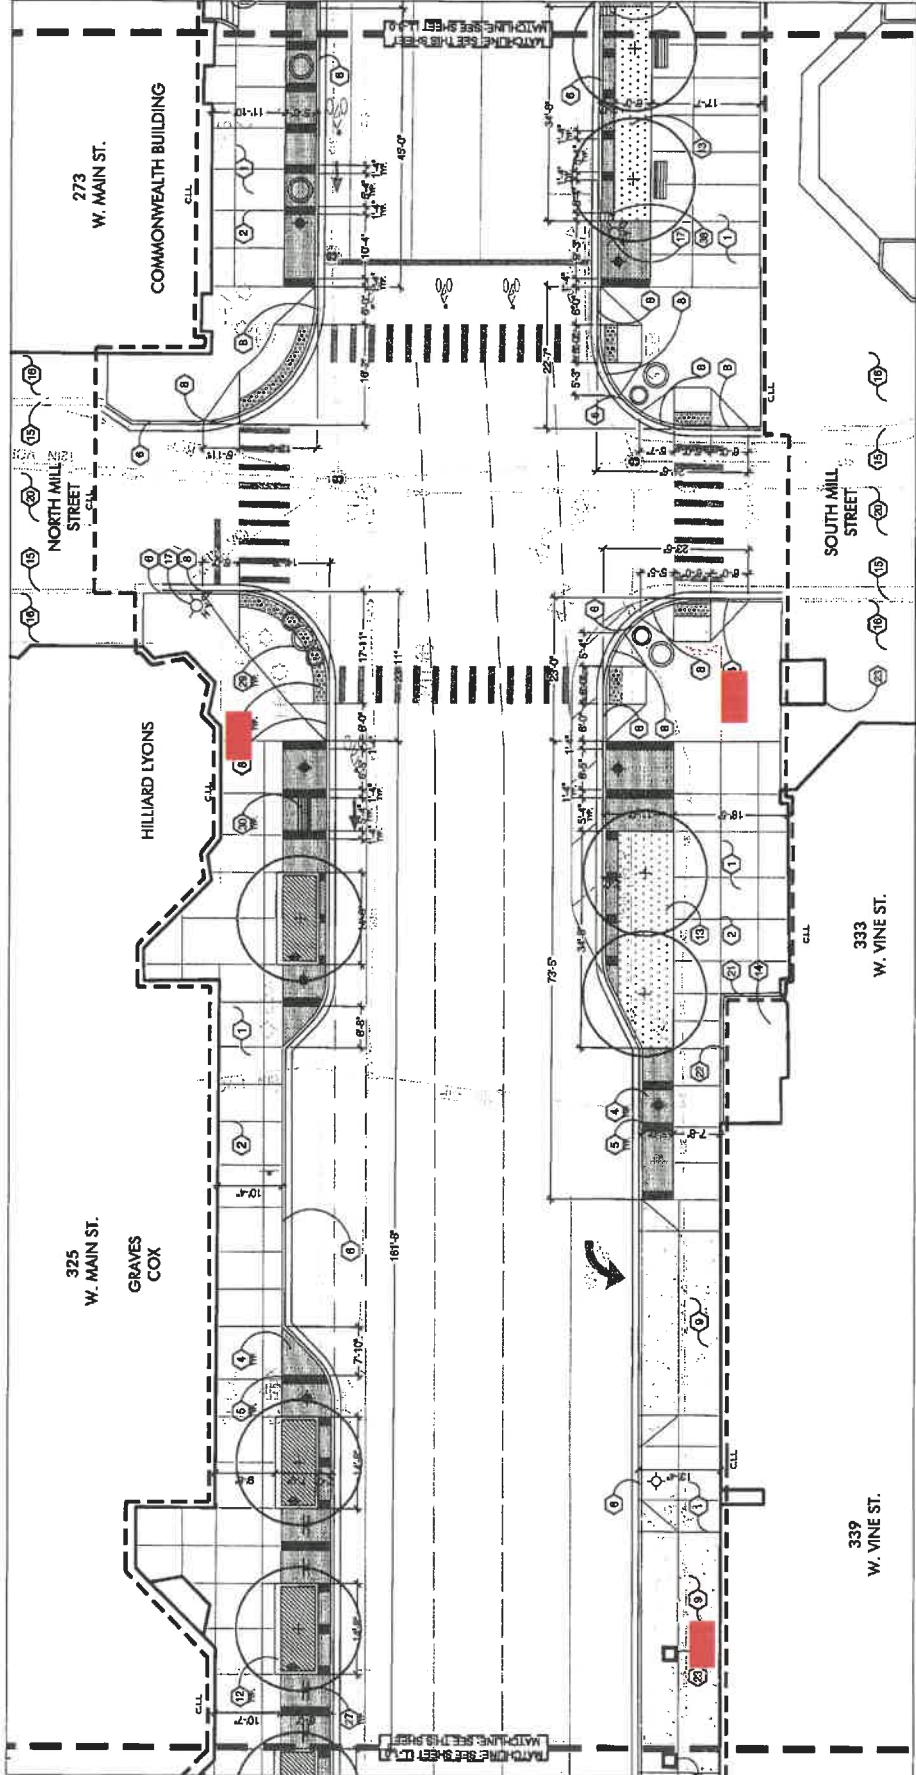


**CONSTRUCTION NOTES**

- 1 CONCRETE PAVEMENT ON GRADE. TYPICAL LIGHT BROOM FINISH. MEET EXISTING GRADES FLUSH. SEE DETAIL 1, SHEET LS-1.0.
- 2 SAWCUT CONTROL JOINT, TYPICAL PER PLANS AND DETAIL 1, SHEET LS-1.0. EXTEND COMPLETELY TO ALL VERTICAL BUILDING FACES.
- 3 EXPANSION JOINT, TYPICAL. SEE DETAIL 1, SHEET LS-1.0.
- 4 UNIT PAVEMENT, TYPE 1 ON CONCRETE BASE. TYPICAL RUNNING CURE TO BE OF ABOVE FINISH GRADE OF ROADWAY. MEET EXISTING GRADES FLUSH. SEE DETAIL 1, SHEET LS-1.0, AND SPEC.
- 5 UNIT PAVEMENT, TYPE 2 ON CONCRETE BASE. TYPICAL RUNNING CURE TO BE OF ABOVE FINISH GRADE OF ROADWAY. MEET EXISTING GRADES FLUSH. SEE DETAIL 1, SHEET LS-1.0, AND SPEC.
- 6 CONCRETE CURB AND GUTTER. TYPICAL FINISH GRADE OF CURB TO BE OF ABOVE FINISH GRADE OF ROADWAY. MEET EXISTING GRADES FLUSH.
- 7 ADA CURB RAMP. MEET EXISTING GRADES FLUSH. PROVIDE REQUIREMENTS. SEE DETAILS 2 & 4, SHEET LS-1.0.
- 8 TRANSITION CURB FROM #7 TO FLUSH.
- 9 HEAVY DUTY CONCRETE PAVEMENT DRIVEWAY APPROACH. MATCH EXISTING DRIVE GRADES AND LAYOUT AT LIMIT OF WORK. SEE DETAIL 2, SHEET LS-1.0.
- 10 TRENCH GRATE. SEE UTILITY PLAN FOR DETAILS.
- 11 TRAFFIC SIGNAL POLE OR SIDEWALK CROSSING SIGNAL. APPROXIMATE LOCATION. SEE TRAFFIC CONTROL PLAN FOR DETAILS.
- 12 RAISED STREET TREE PLANTER. SEE GRADING PLAN FOR TOP OF CURB ELEVATIONS. SEE DETAIL 1 ON SHEET LS-4.0.
- 13 BIODEGRADABLE PLANTER. SEE DETAIL 1, SHEET LS-7.0.
- 14 LANDSCAPE PLANTING BED. SEE PLANTING PLANS, U-SERIES.
- 15 EXISTING CONCRETE CURB. PROTECT IN PLACE. PROPOSED GRADES TO MEET FLUSH.
- 16 EXISTING CONCRETE PAVEMENT TO REMAIN. PROTECT IN PLACE. PROPOSED GRADES TO MEET FLUSH.
- 17 EXISTING FIRE HYDRANT. PROTECT IN PLACE.
- 18 EXISTING SIGN. PROTECT IN PLACE. NEW SIDEWALK TO MEET EXISTING GRADE AT BASE/TOP OF STAIR.
- 19 EXISTING ASPHALT PAVEMENT. PROTECT IN PLACE. PROPOSED GRADES TO MEET EXISTING GRADES FLUSH.
- 20 EXISTING CONCRETE PLANTER CURB TO REMAIN. PROTECT IN PLACE.
- 21 PROPOSED CONCRETE PLANTER CURB. TOP OF WALL TO MEET EXISTING CONCRETE CURB TO REMAIN. SEE DETAIL 5, SHEET LS-1.0.
- 22 EXISTING COLUMN. PROTECT IN PLACE.
- 23 PROPOSED FLAGPOLES. SEE DETAIL 8, SHEET LS-10.0.
- 24 EXISTING UTILITY WALL.
- 25 RECYCLING / WASTE CONTAINER. SEE DETAIL 7, SHEET LS-10.0.
- 26 BIKE RACK. SEE DETAIL 7, SHEET LS-10.0.
- 27 NEWS RACK. SEE DETAIL 5, SHEET LS-10.0.
- 28 FREE STANDING PLANTER. SEE DETAIL 4, SHEET LS-10.0.
- 29 BENCHES. SEE DETAIL 8, SHEET LS-10.0.
- 30 HOOKS. SEE DETAIL 8, SHEET LS-10.0.
- 31 TRANIST SHELTER. SEE DETAIL #. SHEET LS-#.#.
- 32 FULCRUM MARKER. SEE DETAIL #. SHEET LS-1.0.
- 33 EMBEDDED METAL BOLLARD. SEE DETAIL 1, SHEET LS-11.0.
- 34 REMOVABLE METAL BOLLARD. SEE DETAIL 2, SHEET LS-11.0.
- 35 ORNAMENTAL RAIN GARDEN FENCE. SEE DETAIL 3, SHEET LS-11.0.
- 36 RAIN GARDEN CURB INLET AND ORNAMENTAL GRATE. SEE DETAILS 1 & 3, SHEET LS-2.0.
- 37 RELOCATED HISTORIC SIGN.
- 38 RELOCATED WEATHER STATION POLE.
- 39 RELOCATED MAILBOXES.
- 40 GREEN SCREEN PLANTING WALL.

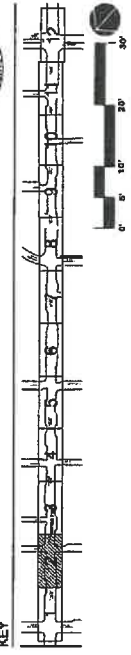


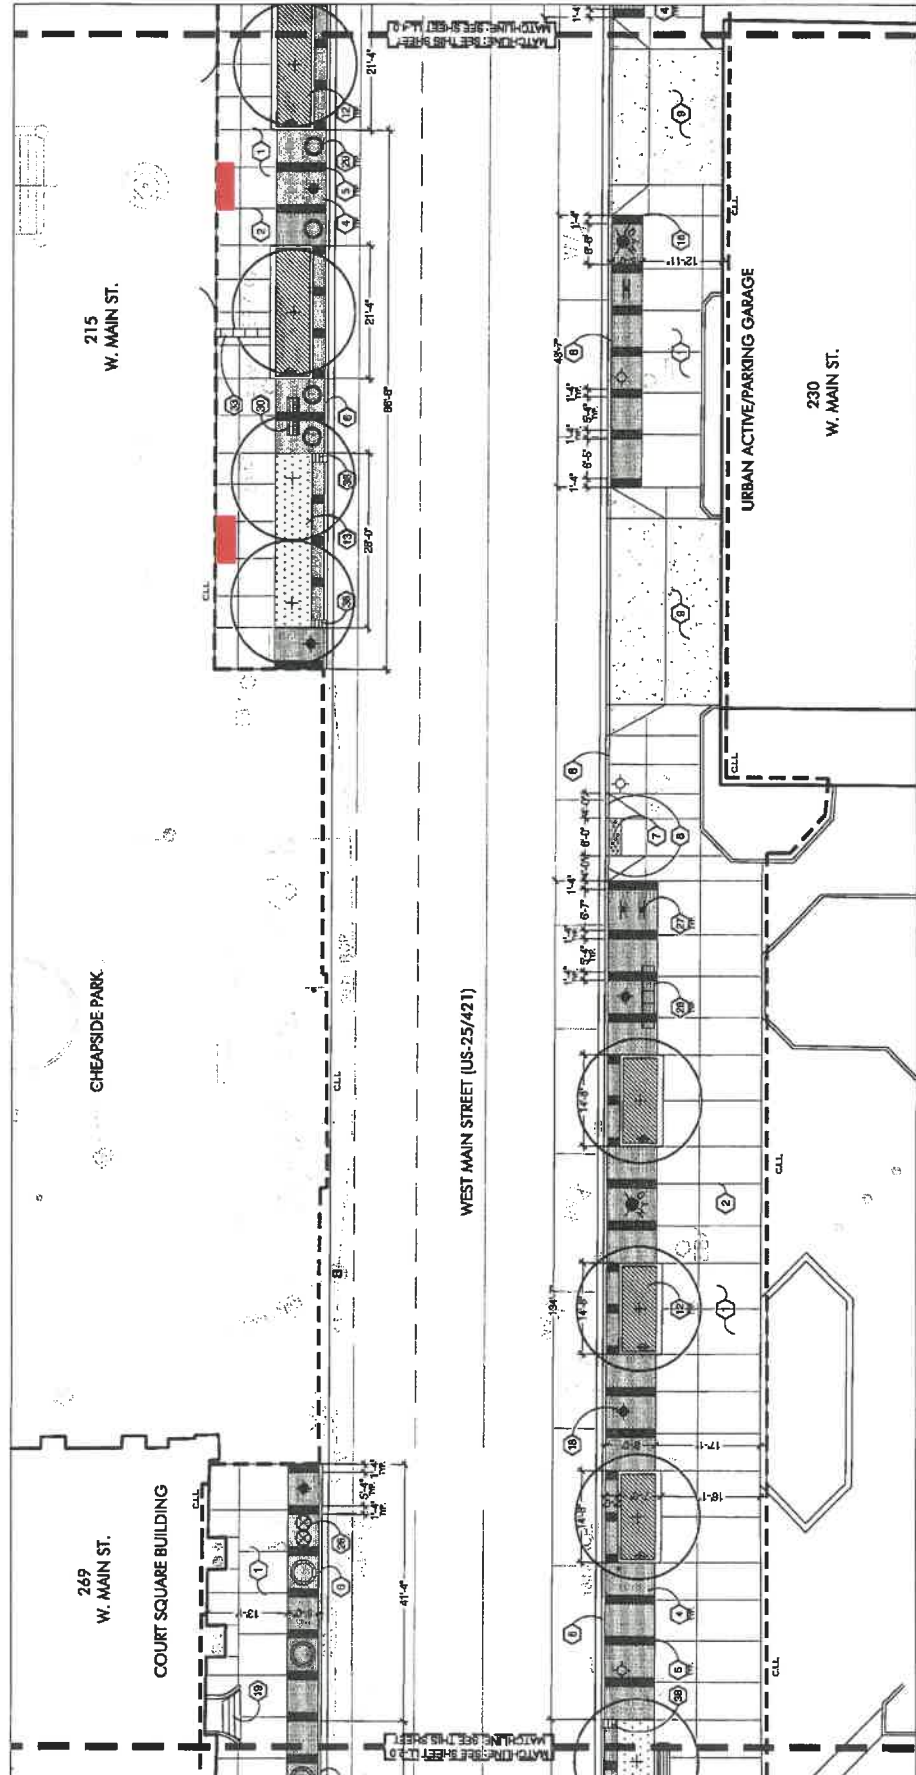

- CONSTRUCTION NOTES**
- (1) CONCRETE CURB AND GUTTER, TYPICAL LIGHT BROOM FINISH, MEET EXISTING GRADES FLUSH. SEE DETAIL 1, SHEET LS-1.0.
  - (2) SAWCUT CONTROL JOINT, TYPICAL PER PLANS AND DETAIL 1, SHEET LS-1.0. EXTEND COMPLETELY TO ALL VERTICAL BUILDING FACES.
  - (3) EXPANSION JOINT, TYPICAL. SEE DETAIL 1, SHEET LS-1.0.
  - (4) UNIT PAVEMENT, TYPE 1 ON CONCRETE BASE, TYPICAL FINISH BOND PATTERN, MEET EXISTING GRADES FLUSH. SEE DETAIL 8, SHEET LS-1.0 AND SPECS.
  - (5) UNIT PAVEMENT, TYPE 2 ON CONCRETE BASE, TYPICAL FINISH BOND PATTERN, MEET EXISTING GRADES FLUSH. SEE DETAIL 8, SHEET LS-1.0 AND SPECS.
  - (6) CONCRETE CURB AND GUTTER, TYPICAL FINISH GRADE OF ROADWAY, MEET EXISTING GRADES FLUSH. PROVIDE REQUIREMENTS. SEE DETAILS 2 & 4, SHEET LS-1.0.
  - (7) TRANSITION CURB FROM 6" TO FLUSH.
  - (8) HEAVY DUTY CONCRETE PAVEMENT DRAINAGE APPROACH, MATCH EXISTING DRIVE GRADES AND LAYOUT AT LIMIT OF WORK. SEE DETAIL 2, SHEET LS-1.0.
  - (9) TRENCH GRATE. SEE UTILITY PLAN FOR DETAILS.
  - (10) TRAFFIC SIGNAL POLE ON PEBBLESTRAN CROSSING SIGNAL APPROXIMATE LOCATION. SEE TRAFFIC CONTROL PLAN FOR DETAILS.
  - (11) RAISED STREET TREE PLANTER. SEE GRADING PLAN FOR TOP OF CURB ELEVATIONS. SEE DETAIL 1 ON SHEET LS-4.0.
  - (12) BIORETENTION PLANTER. SEE DETAIL 1, SHEET LS-7.0.
  - (13) LANDSCAPE PLANTING BED. SEE PLANTING PLANS, LP SERIES.
  - (14) EXISTING CONCRETE CURB. PROTECT IN PLACE. PROPOSED GRADES TO MEET FLUSH.
  - (15) EXISTING FIRE HYDRANT. PROTECT IN PLACE.
  - (16) RELOCATED FIRE HYDRANT.
  - (17) EXISTING STAIR. PROTECT IN PLACE. NEW SIDEWALK TO MEET EXISTING GRADE AT TABE TOP OF STAIR.
  - (18) EXISTING ASPHALT PAVEMENT. PROTECT IN PLACE. PROPOSED GRADES TO MEET EXISTING GRADES FLUSH.
  - (19) EXISTING CONCRETE PLANTER CURB TO REMAIN. PROTECT IN PLACE.
  - (20) PROPOSED CONCRETE PLANTER CURB TO REMAIN. PROTECT IN PLACE.
  - (21) EXISTING CONCRETE PLANTER CURB TO REMAIN. PROTECT IN PLACE.
  - (22) EXISTING CONCRETE PLANTER CURB. TOP OF WALL TO MATCH EXISTING CONCRETE CURB TO REMAIN. SEE DETAIL 5, SHEET LS-1.0.
  - (23) EXISTING COLUMN. PROTECT IN PLACE.
  - (24) PROPOSED FLAGPOLES. SEE DETAIL 8, SHEET LS-10.0.
  - (25) EXISTING UTILITY WALL.
  - (26) RECYCLING / WASTE CONTAINER. SEE DETAIL 7, SHEET LS-10.0.
  - (27) BIKE RACK. SEE DETAIL 7, SHEET LS-10.0.
  - (28) NEWS RACK. SEE DETAILS 5, SHEET LS-10.0.
  - (29) FREE STANDING PLANTER. SEE DETAIL 4, SHEET LS-10.0.
  - (30) BENCHES. SEE DETAIL 8, SHEET LS-10.0.
  - (31) KIOSK. SEE DETAIL 8, SHEET LS-10.0.
  - (32) TRANSIT SHELTER. SEE DETAIL 8, SHEET LS-10.0.
  - (33) FURLONG MOWER. SEE DETAIL 8, SHEET LS-10.0.
  - (34) PAV AND DISPLAY PARKING STATION. SEE DETAIL 3, SHEET LS-10.0.
  - (35) EMBEDDED METAL BOLLARD. SEE DETAIL 1, SHEET LS-11.0.
  - (36) REMOVABLE METAL BOLLARD. SEE DETAIL 2, SHEET LS-11.0.
  - (37) ORNAMENTAL RAIN GARDEN FENCE. SEE DETAIL 3, SHEET LS-11.0.
  - (38) RAIN GARDEN CURB INLET AND ORNAMENTAL GRATE. SEE DETAILS 1 & 3, SHEET LS-4.0.
  - (39) RELOCATED HISTORIC SIGN
  - (40) RELOCATED WEATHER STATION POLE
  - (41) RELOCATED MAILBOXES
  - (42) GREEN SCREEN PLANTING WALL
- KEY**
- 
- Scale: 1" = 12', 1" = 24', 1" = 48'

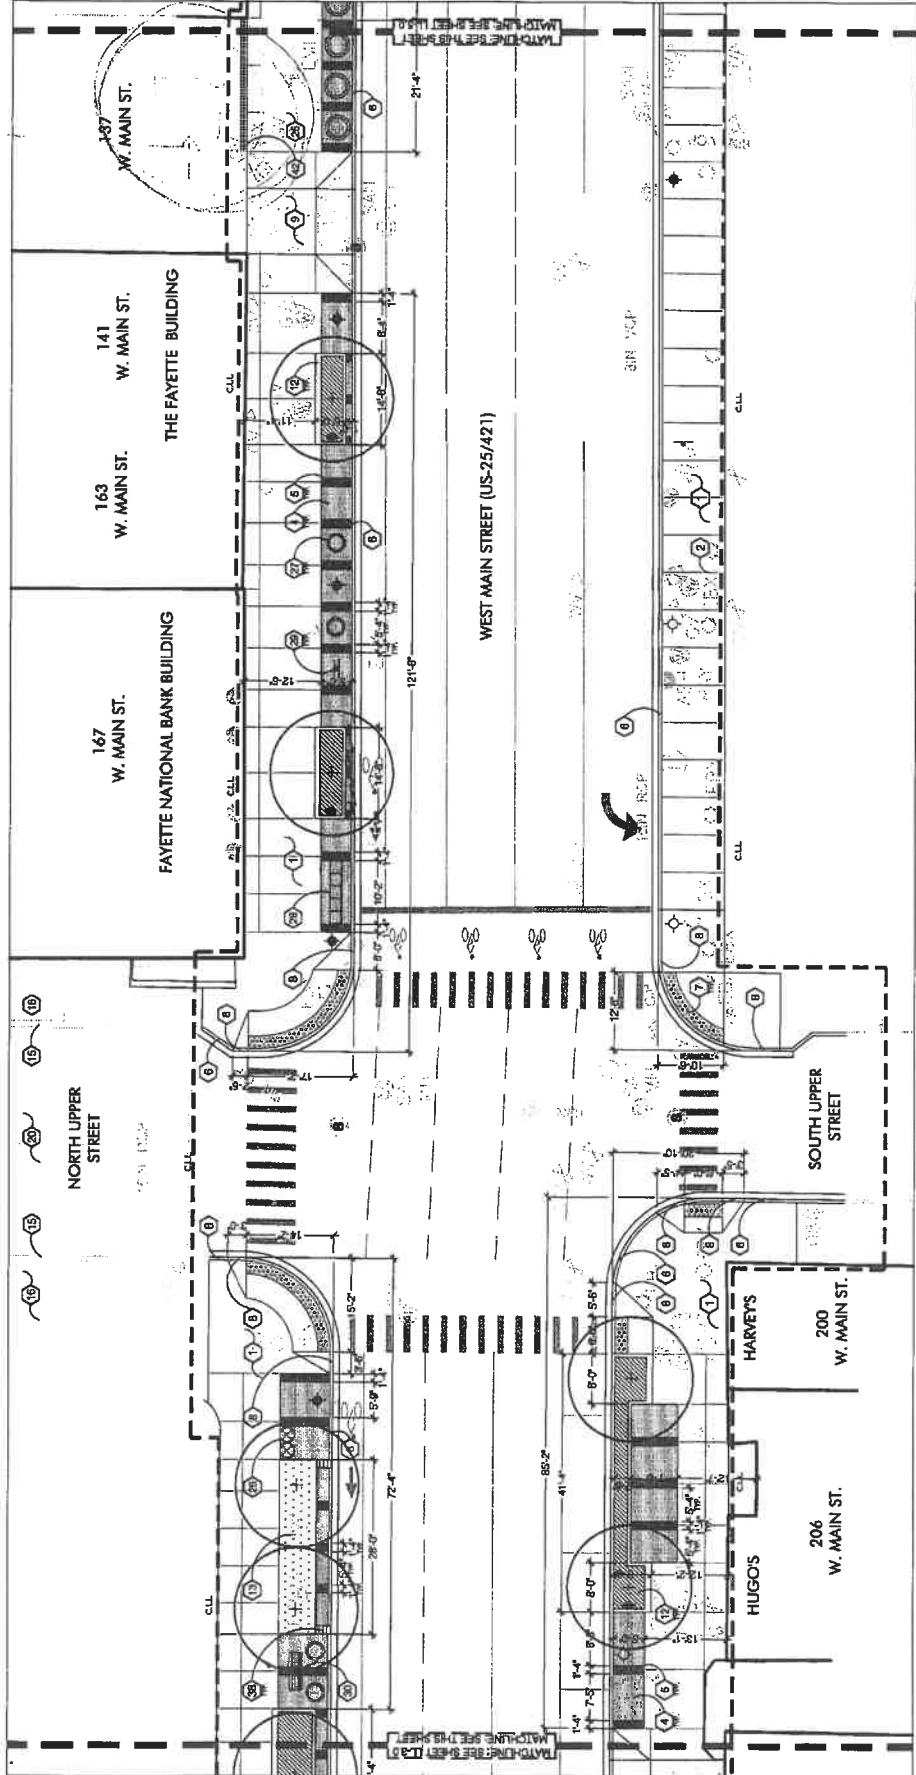

- CONSTRUCTION NOTES**
- 1) CONCRETE PAVEMENT ON GRADE. TYPICAL LIGHT BROOM FINISH. MEET EXISTING GRADES FLUSH. SEE DETAIL 1, SHEET LS-1.0.
  - 2) SAWCUT CONTROL JOINT, TYPICAL. PER PLANS AND DETAIL 1, SHEET LS-1.0. EXTEND COMPLETELY TO ALL VERTICAL BUILDING FACES.
  - 3) EXPANSION JOINT, TYPICAL. SEE DETAIL 1, SHEET LS-1.0.
  - 4) UNIT PAVEMENT, TYPICAL. FINISH GRADE OF CONCRETE BASE. TYPICAL. FINISH GRADE OF CONCRETE CURB. MEET EXISTING GRADES FLUSH. SEE DETAIL 2, SHEET LS-1.0 AND SPEC.
  - 5) UNIT PAVEMENT, TYPICAL. FINISH GRADE OF CONCRETE BASE. TYPICAL. FINISH GRADE OF CONCRETE CURB. MEET EXISTING GRADES FLUSH. MEET EXISTING GRADES FLUSH.
  - 6) ADA CURB RAMP. MEET EXISTING GRADES FLUSH. PROVIDE ASPHALT LIFT AS REQUIRED TO MEET ADA ACCESSIBILITY REQUIREMENTS. SEE DETAILS 2 & 4, SHEET LS-1.0.
  - 7) TRANSITION CURB FROM # 6 TO FLUSH.
  - 8) HEAVY DUTY CONCRETE PAVEMENT DRIVEWAY APPROACH. MATCH EXISTING DRIVE GRADES AND LAYOUT AT LIMIT OF WORK. SEE DETAIL 2, SHEET LS-1.0.
  - 9) TRENCH GRATE. SEE UTILITY PLAN FOR DETAILS.
  - 10) TRAFFIC SIGNAL POLE OR REDESTRAN CROSSING SIGNAL. APPROXIMATE LOCATION. SEE TRAFFIC CONTROL PLAN FOR DETAILS.
  - 11) PRASED STREET TREE PLANTER. SEE GRADING PLAN FOR TOP OF CURB ELEVATIONS. SEE DETAIL 1, SHEET LS-3.0.
  - 12) BIORETENTION PLANTER. SEE DETAIL 1, SHEET LS-7.0.
  - 13) LANDSCAPE PLANTING BED. SEE PLANTING PLANS, U-SERIES.
  - 14) EXISTING CONCRETE CURB. PROTECT IN PLACE. PROPOSED GRADES TO MEET FLUSH.
  - 15) EXISTING CONCRETE PAVEMENT TO REMAIN. PROTECT IN PLACE. PROPOSED GRADES TO MEET FLUSH.
  - 16) EXISTING FIRE HYDRANT. PROTECT IN PLACE.
  - 17) EXISTING FIRE HYDRANT. PROTECT IN PLACE.
  - 18) EXISTING SPACE ABOVE TOP OF SIDEWALK TO MEET EXISTING GRADES FLUSH. PROTECT IN PLACE.
  - 19) EXISTING SPACE ABOVE TOP OF SIDEWALK TO MEET EXISTING GRADES FLUSH. PROTECT IN PLACE.
  - 20) EXISTING SPACE ABOVE TOP OF SIDEWALK TO MEET EXISTING GRADES FLUSH. PROTECT IN PLACE.
  - 21) EXISTING CONCRETE PLANTER CURBS TO REMAIN. PROTECT IN PLACE.
  - 22) PROPOSED CONCRETE IN PATTERN CURBS. TOP OF WALL TO MATCH FLUSH WITH ADJACENT CONCRETE CURB TO REMAIN. SEE DETAIL 5, SHEET LS-4.0.
  - 23) RELOCATED HISTORIC SIGN.
  - 24) PROPOSED FLAGPOLES. SEE DETAIL 8, SHEET LS-10.0.
  - 25) EXISTING UTILITY VAULT.
  - 26) RECYCLING / WASTE CONTAINER. SEE DETAIL 7, SHEET LS-10.0.
  - 27) BIKE RACK. SEE DETAIL 7, SHEET LS-10.0.
  - 28) NEWS RACK. SEE DETAIL 5, SHEET LS-10.0.
  - 29) FREE STANDING PLANTER. SEE DETAIL 4, SHEET LS-10.0.
  - 30) BENCHES. SEE DETAIL 8, SHEET LS-10.0.
  - 31) KIOSK. SEE DETAIL 4, SHEET LS-10.0.
  - 32) TRANSIT SHELTER. SEE DETAIL 9, SHEET LS-4.0.
  - 33) PAV AND DISPLAY PARKING STATION. SEE DETAIL 3, SHEET LS-10.0.
  - 34) EMBEDDED METAL BOLLARD. SEE DETAIL 1, SHEET LS-11.0.
  - 35) REMOVABLE METAL BOLLARD. SEE DETAIL 2, SHEET LS-11.0.
  - 36) ORNAMENTAL RAIN GARDEN FENCE. SEE DETAIL 3, SHEET LS-11.0.
  - 37) RAIN GARDEN CURBS INLET AND ORNAMENTAL GRATE. SEE DETAILS 1 & 3, SHEET LS-9.0.
  - 38) RELOCATED WEATHER STATION POLE.
  - 39) RELOCATED MAILBOXES.
  - 40) GREEN SCREEN PLANTING WALL.

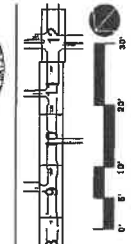

Project Number: 07-1119.3  
 Sheet Title: LAYOUT & MATERIALS PLAN  
 Sheet: LL-4.0

Project Manager: JB  
 Drawn: JMR/ML  
 Checked: JRCB  
 Stamp: [Professional Engineer Seal]

Revisions:  
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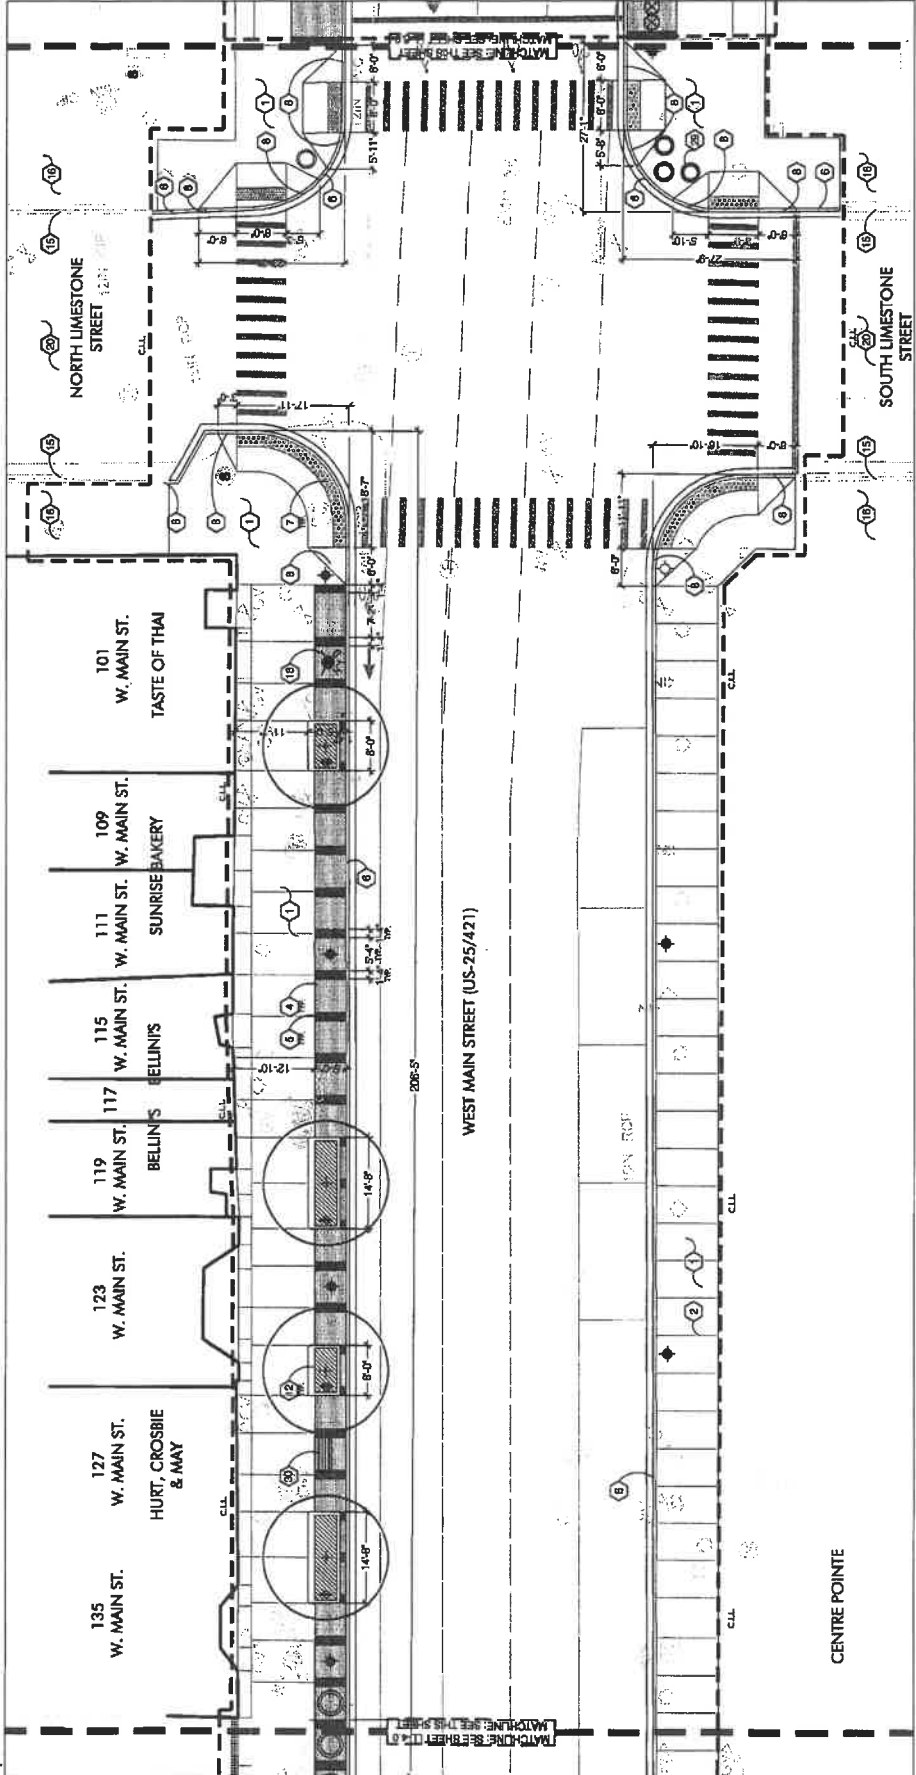
Client: Lexington-Fayette Urban Government  
 200 East Main Street  
 Lexington, KY 40507

Project: Lexington Streetscape  
 Phase 1:  
**MAIN STREET**


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Project: Lexington-Fayette Urban Government  
 200 East Main Street  
 Lexington, KY 40507


Client: Lexington-Fayette Urban Government  
 200 East Main Street  
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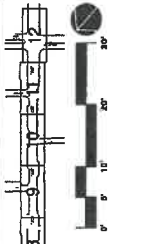
- CONSTRUCTION NOTES**
1. CONCRETE PAVEMENT ON GRADE. TYPICAL LIGHT ROOM FINISH. MEET EXISTING GRADES FLUSH. SEE DETAIL 1, SHEET LS-1.0.
  2. SAWCUT CONTROL JOINT, TYPICAL PER PLANS AND DETAIL 1, SHEET LS-1.0. EXTEND COMPLETELY TO ALL VERTICAL BUILDING FACES.
  3. EXPANSION JOINT, TYPICAL. SEE DETAIL 1, SHEET LS-1.0.
  4. UNIT PAVEMENT, TYPE 1 ON CONCRETE BASE. TYPICAL FINISHING BOND PATTERN. MEET EXISTING GRADES FLUSH. SEE DETAIL 1, SHEET LS-1.0 AND SFPS.
  5. UNIT PAVEMENT, TYPE 2 ON CONCRETE BASE. TYPICAL FINISHING BOND PATTERN. MEET EXISTING GRADES FLUSH. SEE DETAIL 1, SHEET LS-1.0 AND SFPS.
  6. CONCRETE CURB AND GUTTER. TYPICAL FINISH GRADE OF CURB TO BE ABOVE FINISH GRADE OF ROADWAY. MEET EXISTING GRADES FLUSH.
  7. ADA CURB RAMP. MEET EXISTING GRADES FLUSH. PROVIDE ASPHALT LIFT AS REQUIRED TO MEET ADA ACCESSIBILITY REQUIREMENTS. SEE DETAILS 2 & 4, SHEET LS-4.0.
  8. HEAVY DUTY CONCRETE PAVEMENT DRIVEWAY APPROACH. MATCH EXISTING DRIVE GRADES AND LAYOUT AT LIMIT OF WORK. SEE DETAIL 2, SHEET LS-1.0.
  9. TRENCH GRATE. SEE UTILITY PLAN FOR DETAILS.
  10. EXISTING SIGNAL POLE OR RED STRAIN CROSSING SIGNAL. APPROPRIATE LOCATION. SEE TRAFFIC CONTROL PLAN FOR DETAILS.
  11. PROPOSED FLAGPOLES. SEE DETAIL 3, SHEET LS-10.0.
  12. EXISTING UTILITY VAULT.
  13. RECYCLING / WASTE CONTAINER. SEE DETAIL 7, SHEET LS-10.0.
  14. BIKE TRACK. SEE DETAIL 7, SHEET LS-10.0.
  15. NEWS RACK. SEE DETAIL 5, SHEET LS-10.0.
  16. FREE STANDING PLANTER. SEE DETAIL 4, SHEET LS-10.0.
  17. BENCHES. SEE DETAIL 8, SHEET LS-10.0.
  18. HOOKS. SEE DETAIL 8, SHEET LS-10.0.
  19. TRANSIT SHELTER. SEE DETAIL 4, SHEET LS-4.0.
  20. FULCRUM MARKER. SEE DETAIL 9, SHEET LS-1.0.
  21. REMOVABLE METAL BOLLARD. SEE DETAIL 1, SHEET LS-11.0.
  22. EMBEDDED METAL BOLLARD. SEE DETAIL 1, SHEET LS-11.0.
  23. REMOVABLE METAL BOLLARD. SEE DETAIL 2, SHEET LS-11.0.
  24. ORNAMENTAL RAIN GARDEN FENCE. SEE DETAIL 3, SHEET LS-11.0.
  25. RAIN GARDEN CURB INLET AND ORNAMENTAL GRATE. SEE DETAILS 1 & 3, SHEET LS-9.0.
  26. RELOCATED HISTORIC SIGN.
  27. RELOCATED WEATHER STATION POLE.
  28. RELOCATED MAILBOXES.
  29. GREEN SCREEN PLANTING WALL.




Project: Lexington Streetscape Phase 1: MAIN STREET  
 Client: Lexington-Fayette Urban County Government, 200 East Main Street, Lexington, KY 40507  
 Dates: 11.4.2020 Issues, 11.15.2020 Issues, 12.15.2020 Issues  
 Revision: A, B, C, D, E, F, G, H, I, J, K, L, M, N, O, P, Q, R, S, T, U, V, W, X, Y, Z  
 Project Manager: JB  
 Drawn: JMR/WNL  
 Checked: JPC/B  
 Stamp: [Professional Engineer Seal]  
 Project Number: 07-1103  
 Sheet Title: LAYOUT & MATERIALS PLAN  
 Sheet: LL-5.0

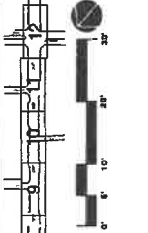

- CONSTRUCTION NOTES**
- CONCRETE PAVEMENT ON GRADE. TYPICAL LIGHT ROOM FINISH. MEET EXISTING GRADES FLUSH. SEE DETAIL 1, SHEET LS-10.0.
  - SAW-CUT CONTROL JOINT. TYPICAL PER PLANS AND DETAIL 1, SHEET LS-10.0. EXTEND COMPLETELY TO ALL VERTICAL BUILDING FACES.
  - EXPANSION JOINT. TYPICAL. SEE DETAIL 1, SHEET LS-10.0.
  - UNIT PAVEMENT, TYPE 1 ON CONCRETE BASE. TYPICAL RUNNING BOND PATTERN. MEET EXISTING GRADES FLUSH. SEE DETAIL 1, SHEET LS-10.0 AND SPECS.
  - UNIT PAVEMENT, TYPE 2 ON CONCRETE BASE. TYPICAL RUNNING BOND PATTERN. MEET EXISTING GRADES FLUSH. SEE DETAIL 1, SHEET LS-10.0 AND SPECS.
  - CONCRETE CURB AND GUTTER. TYPICAL FINISH GRADE OF CURB TO BE AT ABOVE FINISHED GRADE OF ROADWAY. MEET EXISTING GRADES FLUSH.
  - ADA CURB RAMP. MEET EXISTING GRADES FLUSH. PROVIDE ASPHALT LIFT AS REQUIRED TO MEET ADA ACCESSIBILITY REQUIREMENTS. SEE DETAILS 2 & 4, SHEET LS-4.0.
  - HEAVY DUTY CONCRETE PAVEMENT DRIVEWAY APPROACH. MEET EXISTING DRIVE GRADES AND LAYOUT AT LIMIT OF WORK. SEE DETAIL 2, SHEET LS-10.0.
  - TRENCH GRATE. SEE UTILITY PLAN FOR DETAILS.
  - EXISTING COLUMN. PROTECT IN PLACE.
  - PROPOSED FLAGPOLES. SEE DETAIL 9, SHEET LS-10.0.
  - EXISTING UTILITY VAULT.
  - RECYCLING / WASTE CONTAINER. SEE DETAIL 7, SHEET LS-10.0.
  - BIKE RACK. SEE DETAIL 7, SHEET LS-10.0.
  - NEWS RACK. SEE DETAIL 5, SHEET LS-10.0.
  - FREE STANDING PLANTER. SEE DETAIL 4, SHEET LS-10.0.
  - BENCHES. SEE DETAIL 8, SHEET LS-10.0.
  - KIOSK. SEE DETAIL 8, SHEET LS-10.0.
  - TRANSIT SHELTER. SEE DETAIL 4, SHEET LS-4.0.
  - PURLOING MARKER. SEE DETAIL 9, SHEET LS-10.0.
  - EMBEDDED METAL BOLLARD. SEE DETAIL 1, SHEET LS-11.0.
  - REMOVABLE METAL BOLLARD. SEE DETAIL 2, SHEET LS-11.0.
  - ORNAMENTAL RAIN GARDEN FENCE. SEE DETAIL 3, SHEET LS-11.0.
  - RAIN GARDEN CURB INLET AND ORNAMENTAL GRATE. SEE DETAILS 1 & 3, SHEET LS-6.0.
  - RELOCATED HISTORIC SIGN.
  - RELOCATED WEATHER STATION POLE.
  - RELOCATED MAILBOXES.
  - GREEN SCREEN PLANTING WALL.

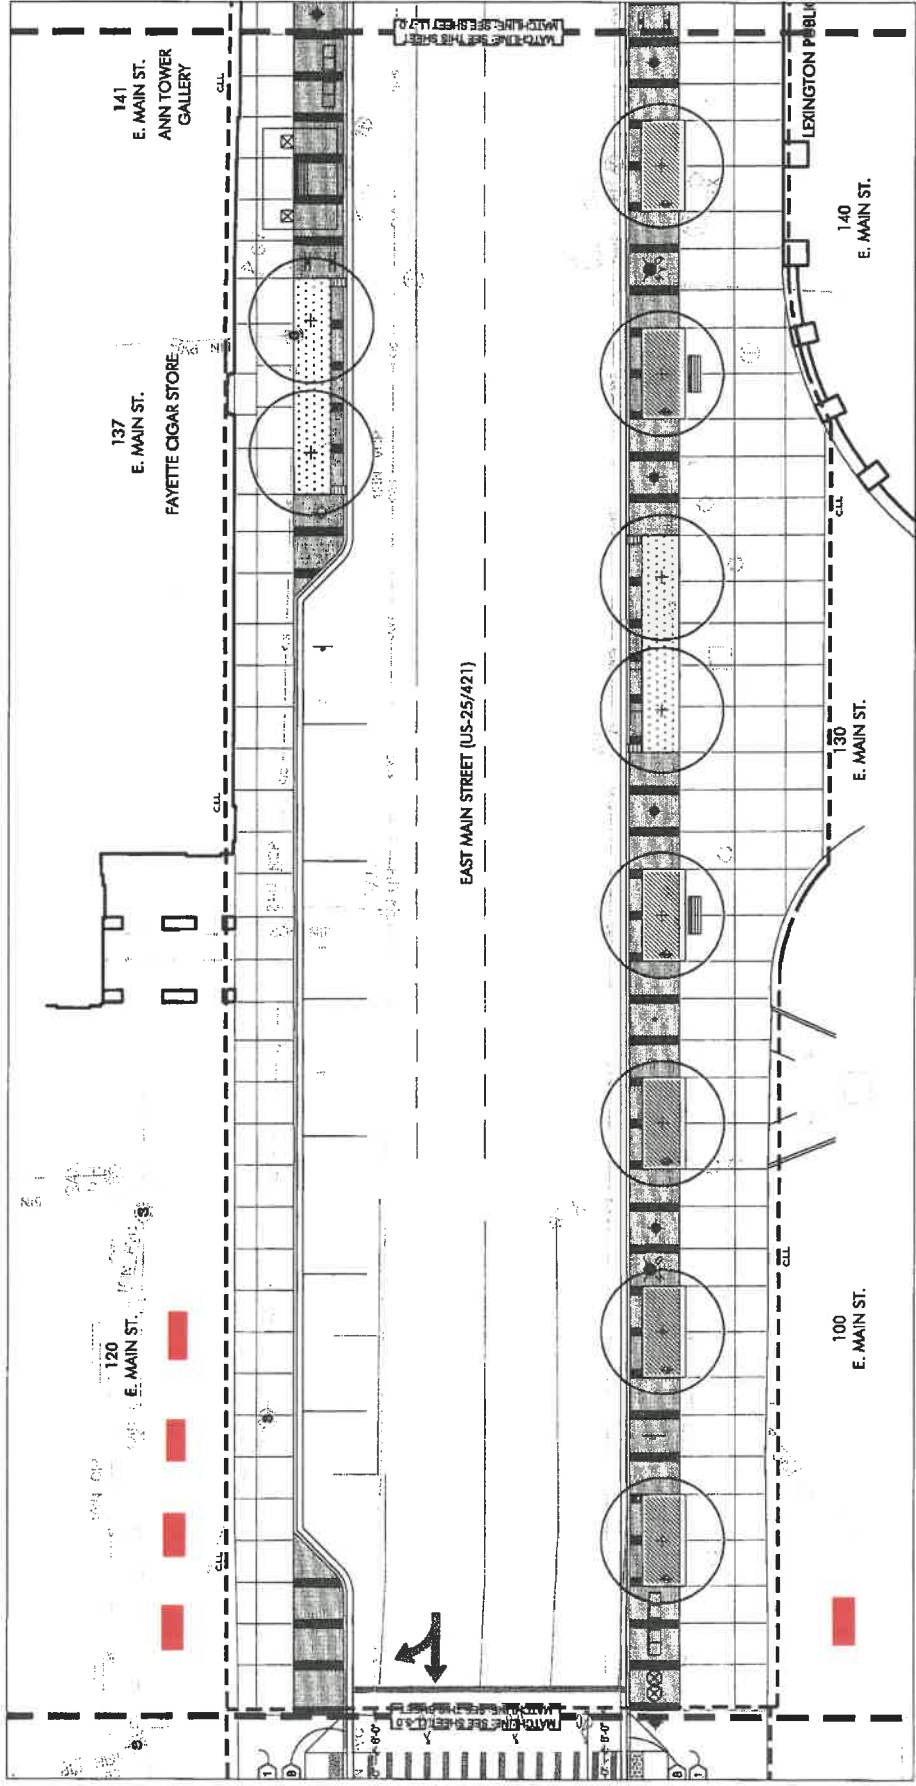

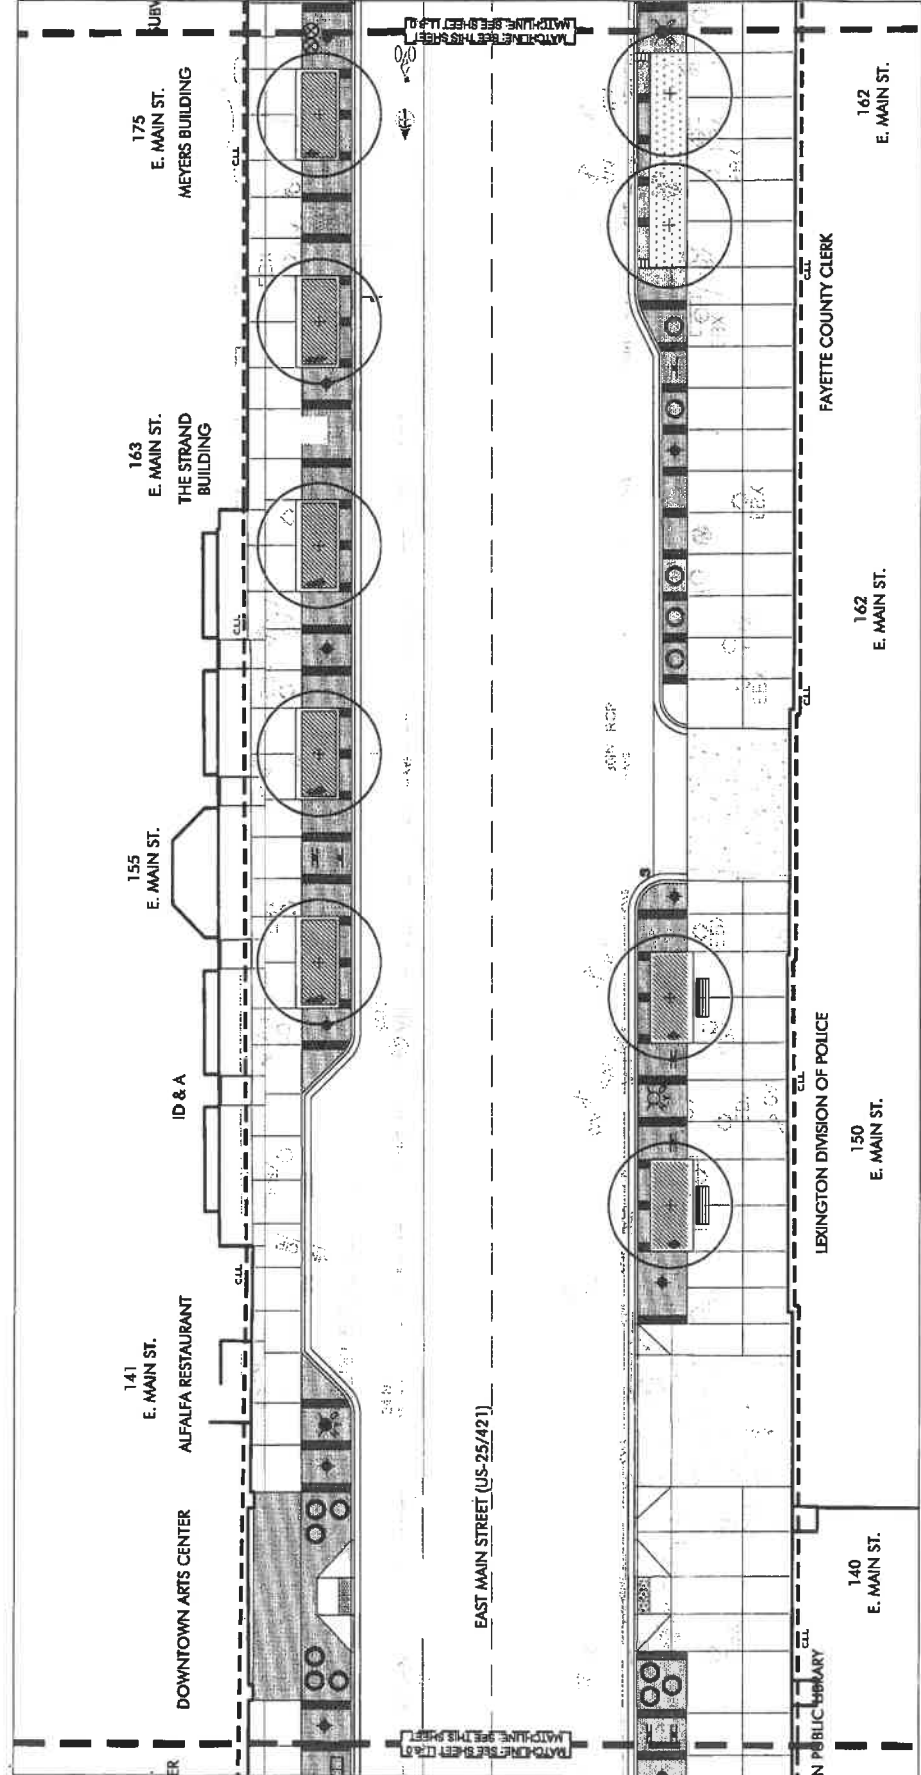

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**Project**  
Client: Lexington, Fayette Urban  
County Government  
200 East Main Street  
Lexington, KY 40507  
Project: Lexington Streetscape  
Phase I:  
MAIN STREET


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**Checked** JR/BC  
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**Project Manager** JB  
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11-14-2019 Revision  
11-18-2019 Revision  
12-16-2019 Revision

Project Number 07-1110.3  
Sheet Title LAYOUT & MATERIALS PLAN  
Sheet LL-7.0

- CONSTRUCTION NOTES**
- 1) CONCRETE PAVEMENT ON GRADE. TYPICAL LIGHT BROOM FINISH. MEET EXISTING GRADES FLUSH. SEE DETAIL 1, SHEET LS-1.0.
  - 2) SAWCUT CONTROL JOINT. TYPICAL PER PLANS AND DETAIL 1, SHEET LS-1.0. EXTEND COMPLETELY TO ALL VERTICAL BUILDING FACES.
  - 3) EXPANSION JOINT. TYPICAL. SEE DETAIL 1, SHEET LS-1.0.
  - 4) UNIT PAVEMENT. TYPICAL. FINISH GRADE OF CURB TO BE AT LEAST FINISHED GRADE OF ROADWAY. MEET EXISTING GRADES FLUSH. SEE DETAIL 2, SHEETS LS-1.0 AND LS-2.0.
  - 5) CONCRETE CURB AND GUTTER. TYPICAL. FINISH GRADE OF CURB TO BE AT LEAST FINISHED GRADE OF ROADWAY. MEET EXISTING GRADES FLUSH.
  - 6) ASPHALT. TYPE 2 ON CONCRETE BASE. TYPICAL. FINISH GRADE OF CURB TO BE AT LEAST FINISHED GRADE OF ROADWAY. MEET EXISTING GRADES FLUSH. SEE DETAIL 2, SHEETS LS-1.0 AND LS-2.0.
  - 7) TRANSITION CURB FROM 8" TO FLUSH.
  - 8) HEAVY DUTY CONCRETE PAVEMENT DRAINWAY APPROACH. MATCH EXISTING DRIVE GRADINGS AND LAYOUT AT LIMIT OF WORK. SEE DETAIL 2, SHEETS LS-1.0.
  - 9) TRENCH GRATE. SEE UTILITY PLAN FOR DETAILS.
  - 10) EXISTING SIGNAL POLE OR RESTRANDED CROSSING SIGNAL. PROTECT IN PLACE.
  - 11) PROPOSED FLAGPOLES. SEE DETAIL 5, SHEET LS-10.0.
  - 12) EXISTING UTILITY VAULT
  - 13) RECYCLING / WASTE CONTAINER. SEE DETAIL 7, SHEET LS-10.0.
  - 14) BIKE RACK. SEE DETAIL 7, SHEET LS-10.0.
  - 15) NEWS RACK. SEE DETAIL 6, SHEET LS-10.0.
  - 16) FREE STANDING PLANTER. SEE DETAIL 4, SHEET LS-10.0.
  - 17) BENCHES. SEE DETAIL 8, SHEET LS-10.0.
  - 18) KIOSK. SEE DETAIL 6, SHEET LS-10.0.
  - 19) TRANSIT SHELTER. SEE DETAIL 8, SHEET LS-11.0.
  - 20) FURLONG MARKER. SEE DETAIL 8, SHEET LS-11.0.
  - 21) RAIL AND DISPLAY PARKING STATION. SEE DETAIL 3, SHEET LS-11.0.
  - 22) EMBEDDED METAL BOLLARD. SEE DETAIL 1, SHEET LS-11.0.
  - 23) REMOVABLE METAL BOLLARD. SEE DETAIL 2, SHEET LS-11.0.
  - 24) ORNAMENTAL RAIN GARDEN FENCE. SEE DETAIL 3, SHEET LS-11.0.
  - 25) RAIN GARDEN CURB INLET AND ORNAMENTAL GRATE. SEE DETAILS 1 & 2, SHEET LS-2.0.
  - 26) RELOCATED HISTORIC SIGN
  - 27) RELOCATED WEATHER STATION POLE
  - 28) RELOCATED MAILBOXES
  - 29) GREEN SCREEN PLANTING WALL
  - 30) EXISTING COLUMN. PROTECT IN PLACE.
  - 31) PROPOSED FLAGPOLES. SEE DETAIL 5, SHEET LS-10.0.
  - 32) EXISTING UTILITY VAULT
  - 33) RECYCLING / WASTE CONTAINER. SEE DETAIL 7, SHEET LS-10.0.
  - 34) BIKE RACK. SEE DETAIL 7, SHEET LS-10.0.
  - 35) NEWS RACK. SEE DETAIL 6, SHEET LS-10.0.
  - 36) FREE STANDING PLANTER. SEE DETAIL 4, SHEET LS-10.0.
  - 37) BENCHES. SEE DETAIL 8, SHEET LS-10.0.
  - 38) KIOSK. SEE DETAIL 6, SHEET LS-10.0.
  - 39) TRANSIT SHELTER. SEE DETAIL 8, SHEET LS-11.0.
  - 40) FURLONG MARKER. SEE DETAIL 8, SHEET LS-11.0.
  - 41) RAIL AND DISPLAY PARKING STATION. SEE DETAIL 3, SHEET LS-11.0.
  - 42) EMBEDDED METAL BOLLARD. SEE DETAIL 1, SHEET LS-11.0.
  - 43) REMOVABLE METAL BOLLARD. SEE DETAIL 2, SHEET LS-11.0.
  - 44) ORNAMENTAL RAIN GARDEN FENCE. SEE DETAIL 3, SHEET LS-11.0.
  - 45) RAIN GARDEN CURB INLET AND ORNAMENTAL GRATE. SEE DETAILS 1 & 2, SHEET LS-2.0.



**KEY**
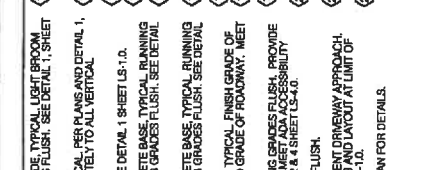
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Promenade Design  
 212 E. Main St.  
 Lexington, KY 40507

Client: LEXINGTON FAYETTE  
 GOVERNMENT CENTER  
 200 East Main Street  
 Lexington, KY 40507  
 Project: Lexington Streetscape  
 Phase 1:  
**MAIN STREET**


Date: 11-4-2010 Revised  
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 12-16-2010 Revised

Revisions: [List of revision triangles]

Project Manager: JB  
 Drawn: JMR/PWL  
 Checked: JRCB  
 Stamp:


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 Sheet Title:  
**LAYOUT & MATERIALS PLAN**

Sheet:  
**LL-8.0**

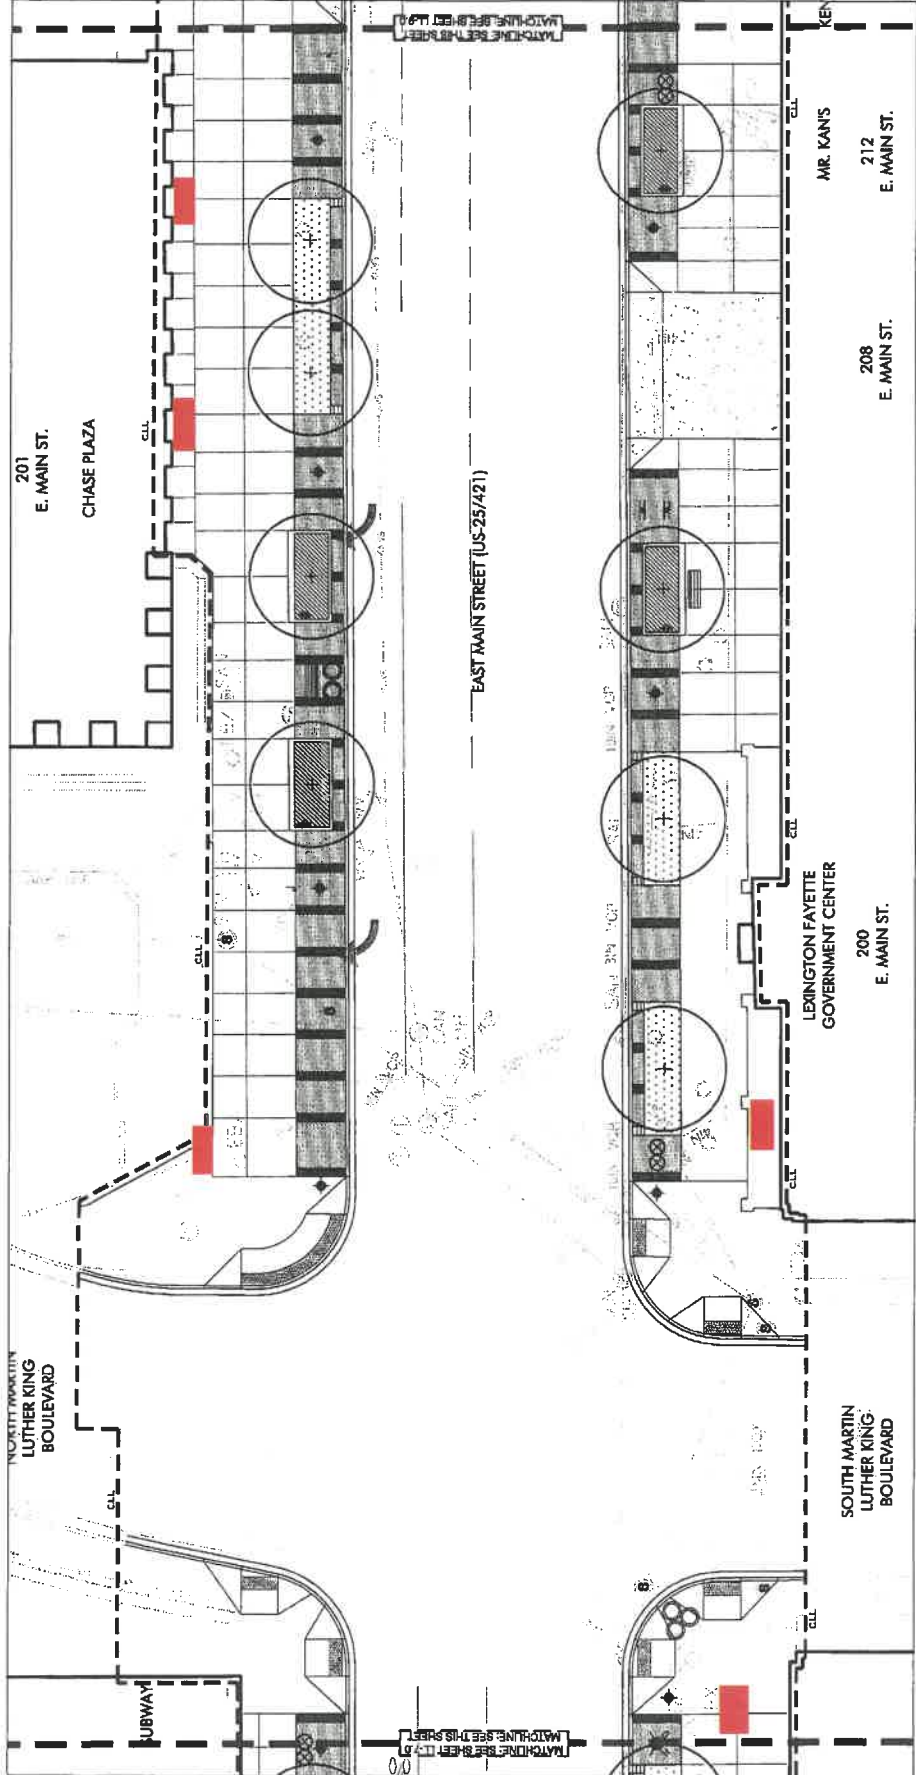



- CONSTRUCTION NOTES**
- 1 CONCRETE PAVEMENT ON GRADE. TYPICAL LIGHT BROOM FINISH. MEET EXISTING GRADES FLUSH. SEE DETAIL 1, SHEET LS-1.0.
  - 2 SAWCUT CONTROL JOINT. TYPICAL. PER PLANS AND DETAIL 1. SHEET LS-1.0. EXTEND COMPLETELY TO ALL VERTICAL BUILDING FACES.
  - 3 EXPANSION JOINT. TYPICAL. SEE DETAIL 1, SHEET LS-1.0.
  - 4 UNIT PAVING. TYPE 1 ON CONCRETE BASE. TYPICAL RUNNING BOND PATTERN. MEET EXISTING GRADES FLUSH. SEE DETAIL 1, SHEET LS-1.0 AND SPEC.
  - 5 UNIT PAVING. TYPE 2 ON CONCRETE BASE. TYPICAL. RUNNING BOND PATTERN. MEET EXISTING GRADES FLUSH. SEE DETAIL 1, SHEET LS-1.0 AND SPEC.
  - 6 CONCRETE CURB AND GUTTER. TYPICAL. FINISH GRADE OF CURB TO BE 6" ABOVE FINISHED GRADE OF ROADWAY. MEET EXISTING GRADES FLUSH.
  - 7 ADA CURB RAMP. MEET EXISTING GRADES FLUSH. PROVIDE ASPHALT LIFTS AS REQUIRED TO MEET ADA ACCESSIBILITY REQUIREMENTS. SEE DETAILS 2 & 4, SHEET LS-4.0.
  - 8 TRANSITION CURB FROM 8" TO 10".
  - 9 HEAVY DUTY CONCRETE PAVEMENT OVERLAY APPROACH MATCH EXISTING DRIVE GRADES AND LAYOUT AT LIMIT OF WORK. SEE DETAIL 2, SHEET LS-1.0.
  - 10 TRENCH GRADE. SEE UTILITY PLAN FOR DETAILS.
  - 11 TRAFFIC SIGNAL POLE OR PEDESTRIAN CROSSING SIGNAL. APPROXIMATE LOCATION. SEE TRAFFIC CONTROL PLAN FOR DETAILS.
  - 12 RAISED STREET TREE PLANTER. SEE GRADING PLAN FOR TOP OF CURB ELEVATIONS. SEE DETAIL 1 ON SHEET LS-4.0.
  - 13 BIORETENTION PLANTER. SEE DETAIL 1, SHEET LS-7.0.
  - 14 LANDSCAPE PLANTING BED. SEE PLANTING PLANS, LP SERIES.
  - 15 EXISTING CONCRETE CURB. PROTECT IN PLACE. PROPOSED GRADES TO MEET FLUSH.
  - 16 EXISTING CONCRETE CURB. PROTECT IN PLACE. PROPOSED GRADES TO MEET FLUSH.
  - 17 EXISTING FIRE HYDRANT. PROTECT IN PLACE.
  - 18 RELOCATED FIRE HYDRANT.
  - 19 EXISTING SIGN. PROTECT IN PLACE. NEW SIDEWALK TO MEET EXISTING SIGN. PROTECT TOP OF SIGN.
  - 20 EXISTING ASPHALT TAMPED. PROTECT IN PLACE. PROPOSED GRADES TO MEET EXISTING GRADES FLUSH.
  - 21 EXISTING CONCRETE PLANTER CURB TO REMAIN. PROTECT IN PLACE.
  - 22 PROPOSED CONCRETE PLANTER CURB. TOP OF WALL TO MEET EXISTING CONCRETE CURB TO REMAIN. SEE DETAIL 5, SHEET LS-1.0.
  - 23 EXISTING COLUMN. PROTECT IN PLACE.
  - 24 PROPOSED FLAGPOLES. SEE DETAIL 8, SHEET LS-10.0.
  - 25 EXISTING UTILITY VAULT.
  - 26 RECYCLING / WASTE CONTAINER. SEE DETAIL 7, SHEET LS-10.0.
  - 27 BIKE RACK. SEE DETAIL 7, SHEET LS-10.0.
  - 28 NEWS RACK. SEE DETAIL 5, SHEET LS-10.0.
  - 29 FREE STANDING PLANTER. SEE DETAIL 4, SHEET LS-10.0.
  - 30 BENCHES. SEE DETAIL 8, SHEET LS-10.0.
  - 31 HOOKS. SEE DETAIL 8, SHEET LS-10.0.
  - 32 TRANSIT SHELTER. SEE DETAIL 4, SHEET LS-4.0.
  - 33 FUELING MARKER. SEE DETAIL 8, SHEET LS-1.0.
  - 34 TV AND DISPLAY PARKING STATION. SEE DETAIL 3, SHEET LS-10.0.
  - 35 EMBEDDED METAL BOLLARD. SEE DETAIL 1, SHEET LS-11.0.
  - 36 REMOVABLE METAL BOLLARD. SEE DETAIL 2, SHEET LS-11.0.
  - 37 ORNAMENTAL PAIN GARDEN FENCE. SEE DETAIL 3, SHEET LS-11.0.
  - 38 RAIN GARDEN CURB INLET AND ORNAMENTAL GRATE. SEE DETAILS 1 & 3, SHEET LS-2.0.
  - 39 RELOCATED HISTORIC SIGN.
  - 40 RELOCATED WEATHER STATION POLE.
  - 41 RELOCATED MAILBOXES.
  - 42 GREEN SCREEN PLANTING WALL.
- KEY**
-




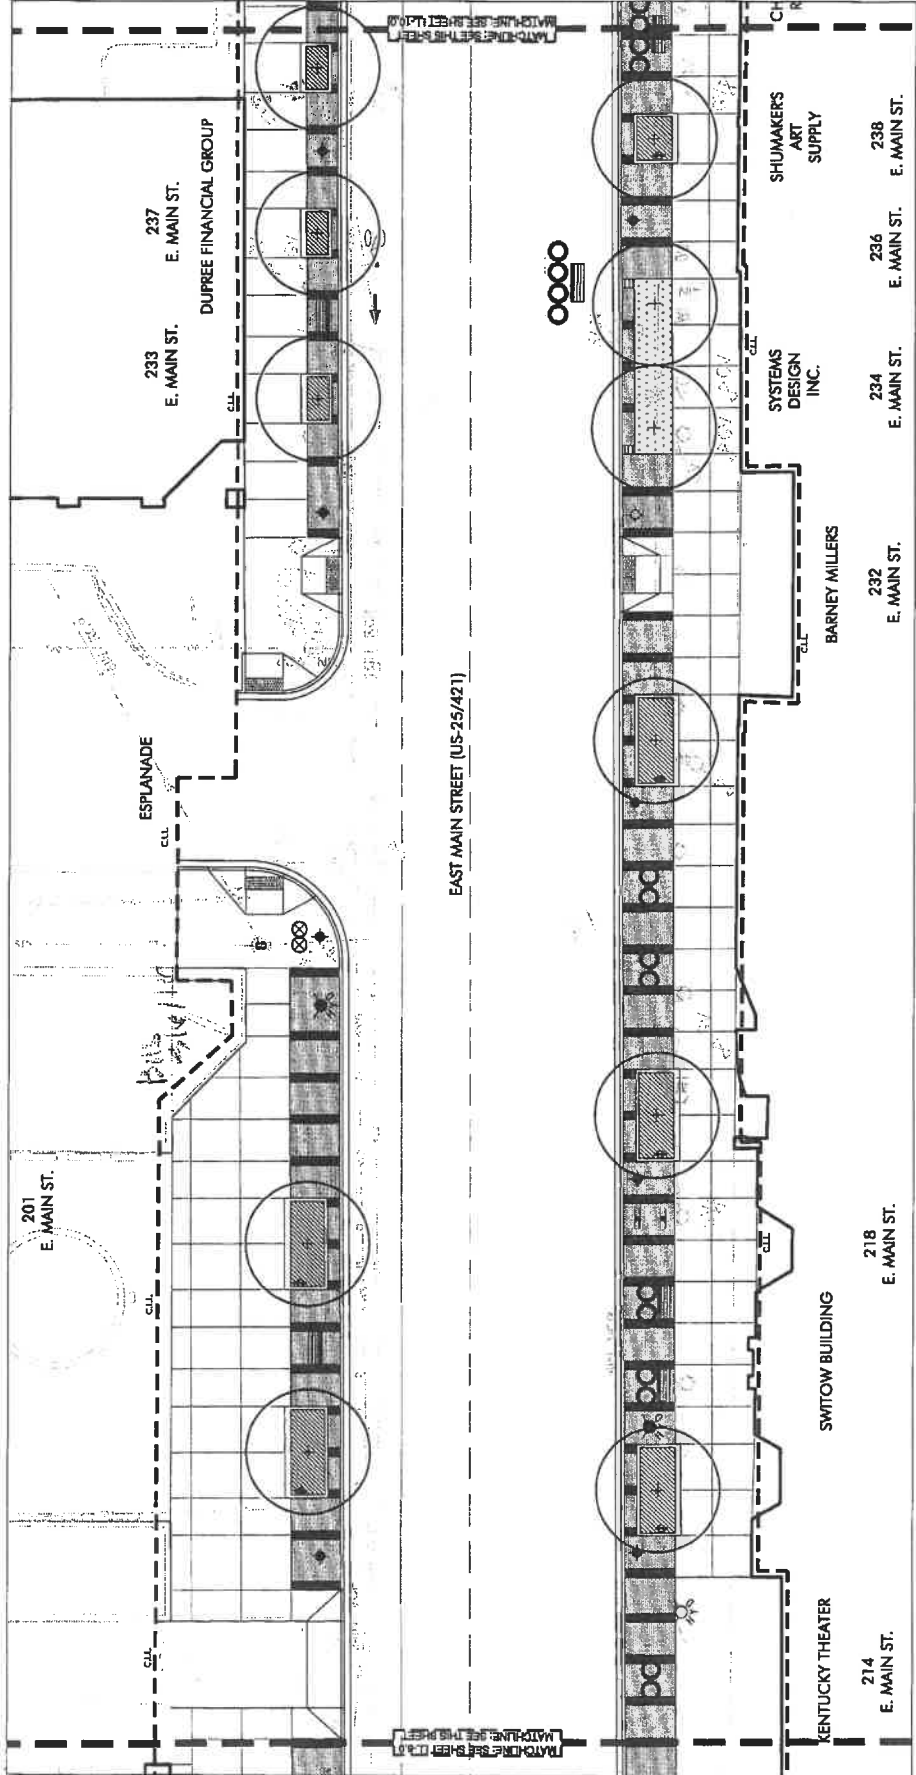



- CONSTRUCTION NOTES**
- CONCRETE PAVEMENT ON GRADE. TYPICAL LIGHT BROOM FINISH. MEET EXISTING GRADES FLUSH. SEE DETAIL 1, SHEET LS-1.0.
  - SMOOTH CONTROL JOINT. TYPICAL PER PLANS AND DETAIL 1, SHEET LS-1.0. JOINTS SHALL BE LOCATED COMPLETELY TO ALL VERTICAL BUILDING FACES.
  - EXPANSION JOINT. TYPICAL. SEE DETAIL 1, SHEET LS-1.0.
  - UNIT PAVEMENT. TYPE 1.0N CONCRETE BASE. TYPICAL FINISH GRADATIONS. MEET EXISTING GRADES FLUSH. SEE DETAIL 1, SHEET LS-1.0.
  - UNIT PAVEMENT. TYPE 2.0N CONCRETE BASE. TYPICAL FINISH GRADATIONS. MEET EXISTING GRADES FLUSH. SEE DETAIL 1, SHEET LS-1.0.
  - CONCRETE CURB AND GUTTER. TYPICAL FINISH GRADE OF CURB TO BE ABOVE FINISHED GRADE OF ROADWAY. MEET EXISTING GRADES FLUSH.
  - ADA CURB RAMP. MEET EXISTING GRADES FLUSH. PROVIDE ASPHALT LIFT AS REQUIRED TO MEET ADA ACCESSIBILITY REQUIREMENTS. SEE DETAILS 2 & 4, SHEET LS-1.0.
  - HEAVY DUTY CONCRETE PAVEMENT DRIVENWAY APPROACH. MEET EXISTING DRIVE GRADES AND LAYOUT AT LIMIT OF WORK. SEE DETAIL 2, SHEET LS-1.0.
  - TRENCH GRATE. SEE UTILITY PLAN FOR DETAILS.
  - EXISTING COLUMN. PROTECT IN PLACE.
  - PROPOSED FLAGPOLES. SEE DETAIL 6, SHEET LS-10.0.
  - EXISTING UTILITY VAULT.
  - RECYCLING / WASTE CONTAINER. SEE DETAIL 7, SHEET LS-10.0.
  - BIKE RACK. SEE DETAIL 7, SHEET LS-10.0.
  - NEWS RACK. SEE DETAIL 5, SHEET LS-10.0.
  - FREE STANDING PLANTER. SEE DETAIL 4, SHEET LS-10.0.
  - BENCHES. SEE DETAIL 8, SHEET LS-10.0.
  - HOOKS. SEE DETAIL 8, SHEET LS-10.0.
  - TRANSIT SHELTER. SEE DETAIL 4, SHEET LS-10.0.
  - FULL LENGTH MARKER. SEE DETAIL 8, SHEET LS-10.0.
  - EMBEDDED METAL BOLLARD. SEE DETAIL 1, SHEET LS-11.0.
  - REMOVABLE METAL BOLLARD. SEE DETAIL 2, SHEET LS-11.0.
  - ORNAMENTAL RAIN GARDEN FENCE. SEE DETAIL 3, SHEET LS-11.0.
  - RAIN GARDEN CURB INLET AND ORNAMENTAL GRATE. SEE DETAILS 1 & 3, SHEET LS-9.0.
  - RELOCATED HISTORIC SIGN.
  - RELOCATED WEATHER STATION POLE.
  - RELOCATED MAILBOXES.
  - GREEN SCREEN PLANTING WALL.

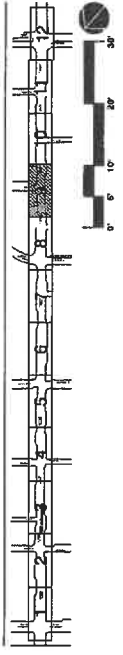

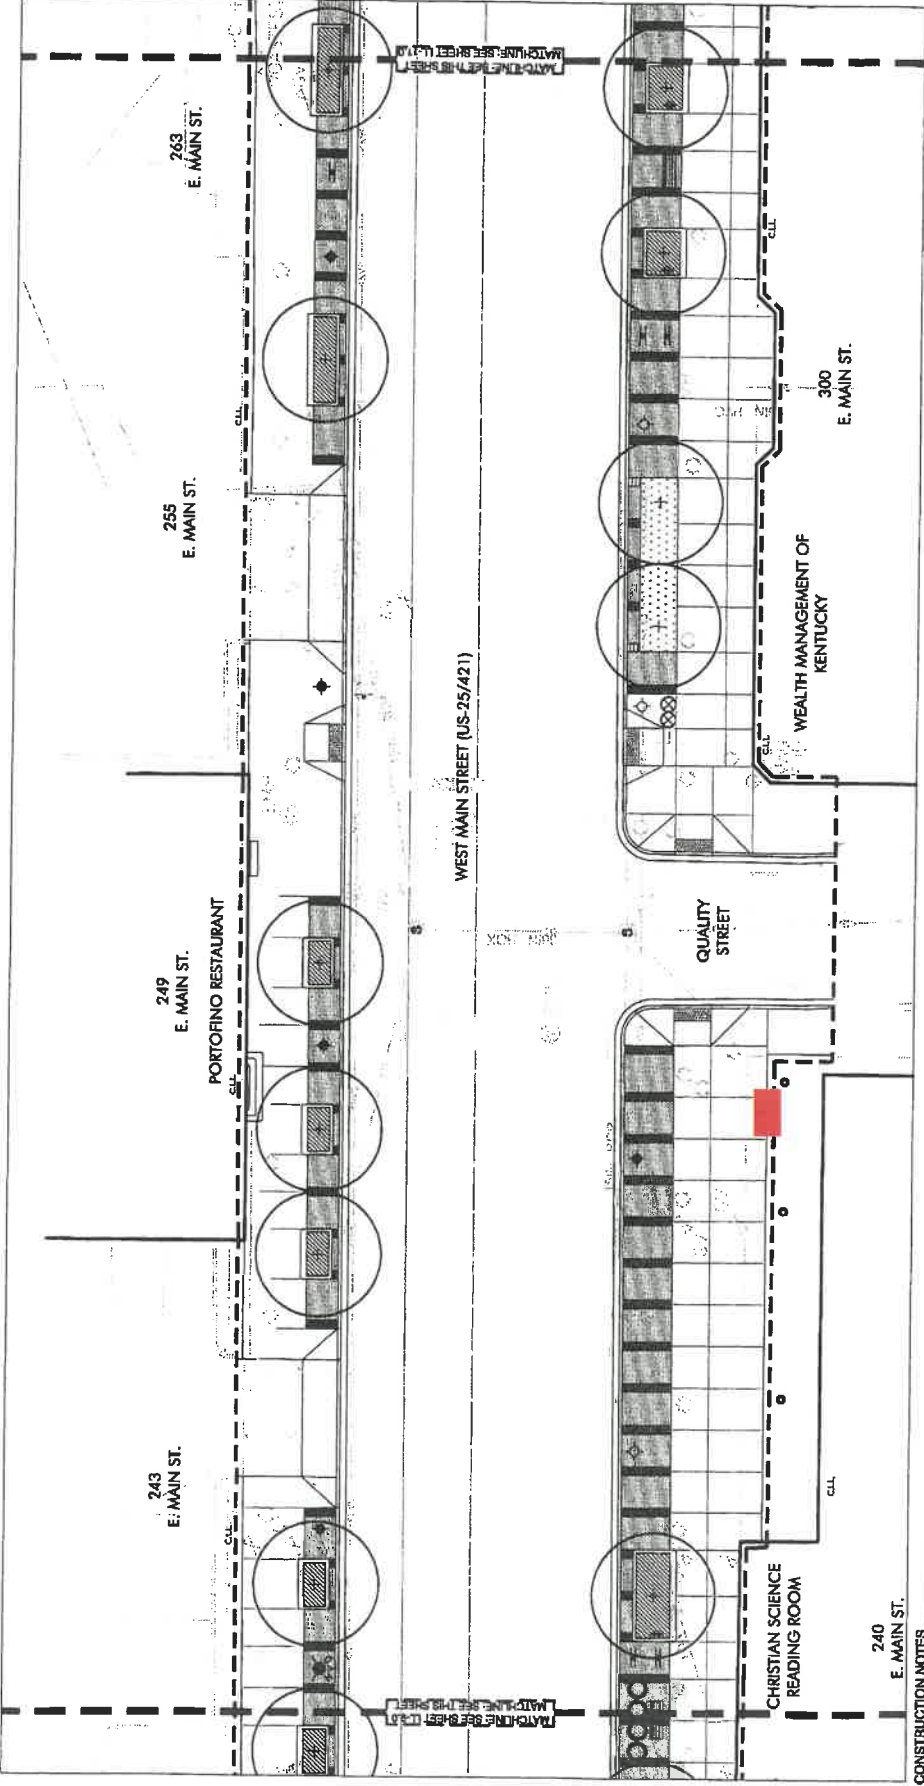

- CONSTRUCTION NOTES**
- CONCRETE PAVEMENT ON GRADE, TYPICAL LIGHT BROOM, MEET EXISTING GRADES FLUSH, SEE DETAIL 1, SHEET LS-10.0.
  - SAMPLE CONTRACT, UNIT TYPICAL, SEE PLANS AND DETAIL 1, SHEET LS-10.0 EXTEND COMPLETELY TO ALL VERTICAL BUILDING FACES.
  - EXPANSION JOINT, TYPICAL, SEE DETAIL 1, SHEET LS-10.0.
  - UNIT PAPER, TYPE 2 ON CONCRETE BASE, TYPICAL, RANING BOND PATTERN, MEET EXISTING GRADES FLUSH, SEE DETAIL 8 SHEET LS-10.0 AND SHEET 8.
  - UNIT PAPER, TYPE 2 ON CONCRETE BASE, TYPICAL, RANING BOND PATTERN, MEET EXISTING GRADES FLUSH, SEE DETAIL 8 SHEET LS-10.0, AND SHEET 8.
  - CONCRETE CURB AND GUTTER, TYPICAL, FINISH GRADE OF EXISTING UNFINISHED GRADE OF ROADWAY, MEET EXISTING UNFINISHED GRADES FLUSH.
  - ASPH CURB RAMP, MEET EXISTING GRADES FLUSH, PROVIDE REQUIREMENTS, SEE DETAILS 2 & 4 SHEET LS-4.0.
  - TRANSITION CURB FROM 6" TO FLUSH.
  - HEAVY DUTY CONCRETE PAVEMENT DRIVEWAY APPROACH, MEET EXISTING GRADES FLUSH, SEE DETAIL 2, SHEET LS-10.0.
  - TRENCH GRATE, SEE UTILITY PLAN FOR DETAILS.
  - TRAFFIC SIGNAL POLE OR PEDESTRIAN CROSSING SIGNAL, APPROXIMATE LOCATION, SEE TRAFFIC CONTROL PLAN FOR DETAILS.
  - RASED STREET TREE PLANTER, SEE GRADING PLAN FOR TOP OF CURB ELEVATIONS, SEE DETAIL 1 ON SHEET LS-6.0.
  - BIORETENTION PLANTER, SEE DETAIL 1, SHEET LS-7A.
  - LANDSCAPE PLANTING BED, SEE PLANTING PLANS, LP SERIES.
  - EXISTING CONCRETE CURB, PROTECT IN PLACE, PROPOSED GRADES TO MEET FLUSH.
  - EXISTING CONCRETE CURB, PROTECT IN PLACE, PROPOSED GRADES TO MEET FLUSH.
  - EXISTING FIRE HYDRANT, PROTECT IN PLACE.
  - RELOCATED FIRE HYDRANT.
  - EXISTING STAIR, PROTECT IN PLACE, NEW SIDEWALK TO MEET EXISTING GRADE AT BASE TOP OF STAIR.
  - EXISTING ASPHALT PAVEMENT, PROTECT IN PLACE.
  - PROPOSED GRADES TO MEET EXISTING GRADES FLUSH.
  - EXISTING CONCRETE PLANTER CURB TO REMAIN, PROTECT IN PLACE.
  - PROPOSED CONCRETE PLANTER CURB, TOP OF WALL TO MATCH FLUSH WITH ADJACENT CONCRETE CURB TO REMAIN, SEE DETAIL 5, SHEET LS-10.0.
  - EXISTING COLUMN, PROTECT IN PLACE.
  - PROPOSED FLAGPOLES, SEE DETAIL 9, SHEET LS-10.0.
  - EXISTING UTILITY VAULT.
  - RECYCLING / WASTE CONTAINER, SEE DETAIL 7, SHEET LS-10.0.
  - BIKE RACK, SEE DETAIL 7, SHEET LS-10.0.
  - NEWS RACK, SEE DETAIL 5, SHEET LS-10.0.
  - FREE STANDING PLANTER, SEE DETAIL 4, SHEET LS-10.0.
  - BENCHES, SEE DETAIL 8, SHEET LS-10.0.
  - WROSK, SEE DETAIL 8, SHEET LS-10.0.
  - TRANSIT SHELTER, SEE DETAIL 6, SHEET LS-4-B.
  - PURCHING WAGON, SEE DETAIL 9, SHEET LS-10.0.
  - AS AND DISPLAY PARKING STATION, SEE DETAIL 3, SHEET LS-11.0.
  - EMBEDDED METAL BOLLARD, SEE DETAIL 1, SHEET LS-11.0.
  - REMOVABLE METAL BOLLARD, SEE DETAIL 2, SHEET LS-11.0.
  - ORNAMENTAL RAIN GARDEN FENCE, SEE DETAIL 3, SHEET LS-11.0.
  - RAIN GARDEN CURB INLET AND ORNAMENTAL GRATE, SEE DETAILS 1 & 3, SHEET LS-9.0.
  - RELOCATED HISTORIC SIGN.
  - RELOCATED WEATHER STATION POLE.
  - RELOCATED MAILBOXES.
  - GREEN SCREEN PLANTING WALL.

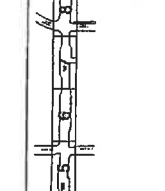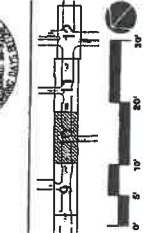

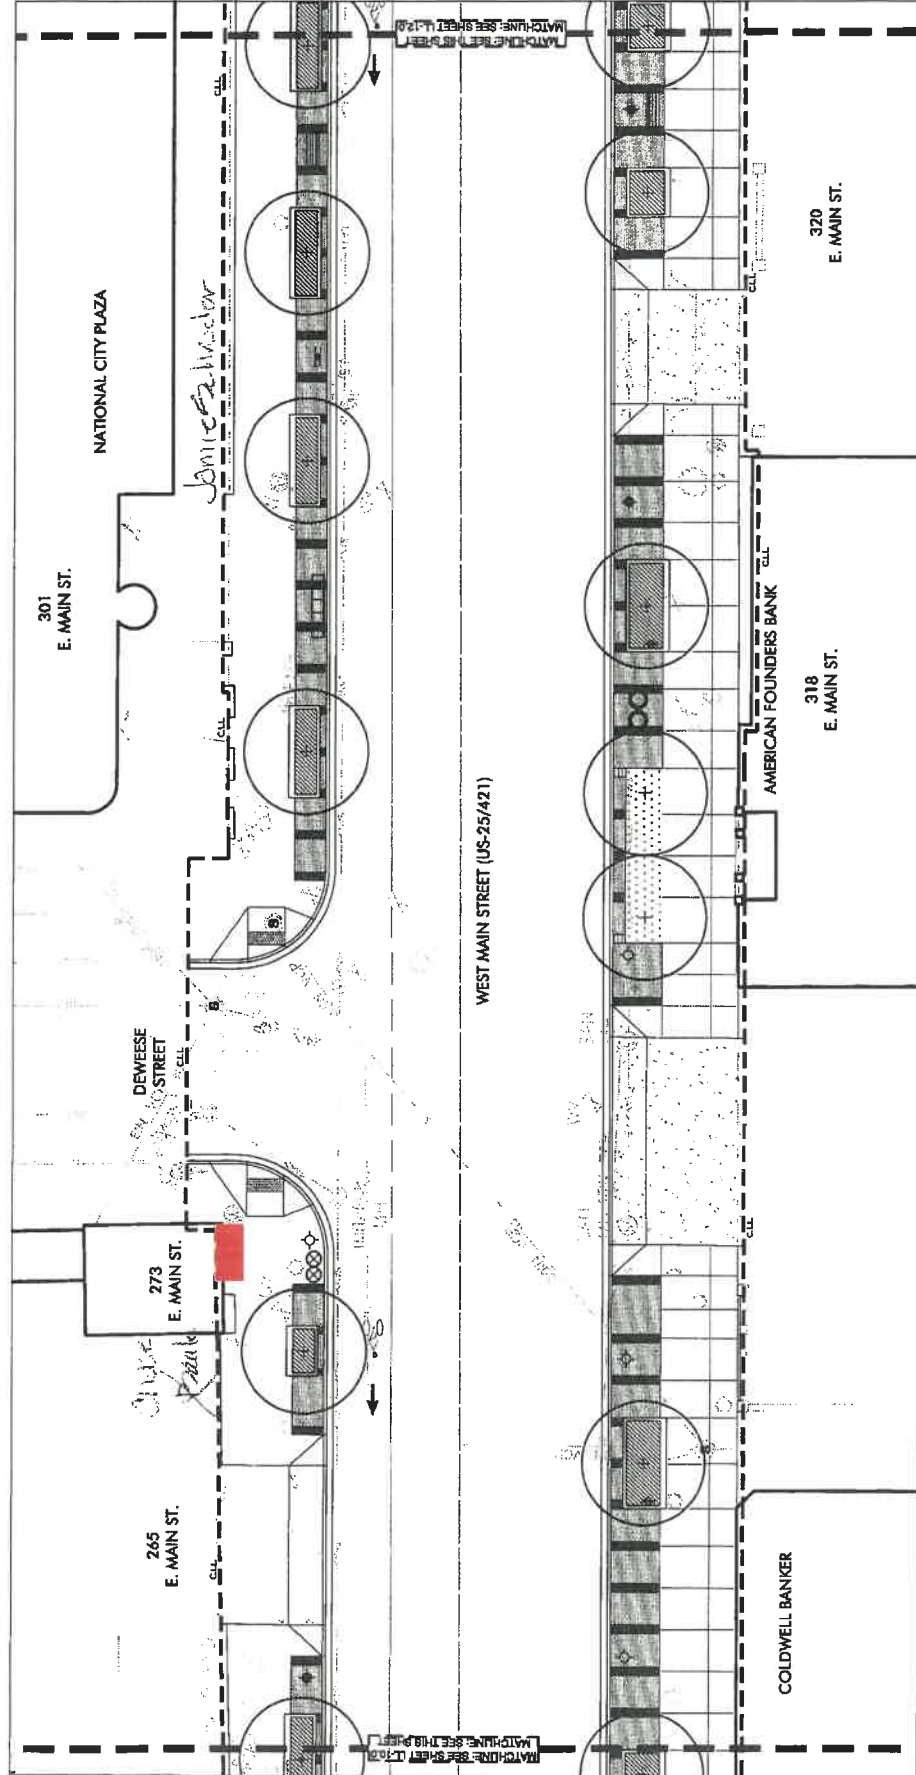

- CONSTRUCTION NOTES**
- CONCRETE PAVEMENT ON GRADE. TYPICAL LIGHT BROOM FINISH. MEET EXISTING GRADES FLUSH. SEE DETAIL 1, SHEET LS-1.0.
  - TRAFFIC SIGNAL POLE OR PEDESTRIAN CROSSING SIGNAL. APPROXIMATE LOCATION. SEE TRAFFIC CONTROL PLAN FOR DETAILS.
  - PAVED STREET TREE PLANTER. SEE GRADING PLAN FOR TOP OF CURB ELEVATIONS. SEE DETAIL 1 ON SHEET LS-5.0.
  - LANDSCAPE PLANTING BED. SEE PLANTING PLANS, LP SERIES.
  - EXISTING CONCRETE CURB. PROTECT IN PLACE. PROPOSED GRADIES TO MEET FLUSH.
  - EXISTING CONCRETE PAVEMENT TO REMAIN. PROTECT IN PLACE. PROPOSED GRADIES TO MEET FLUSH.
  - EXISTING FIRE HYDRANT. PROTECT IN PLACE.
  - EXISTING STAR. PROTECT IN PLACE. NEW SIDEWALK TO MEET EXISTING STAR AT BASE/TOP OF STAIR. PROTECT IN PLACE.
  - EXISTING ASPHALT PAVEMENT. PROTECT IN PLACE. PROPOSED GRADIES TO MEET EXISTING GRADES FLUSH.
  - EXISTING CONCRETE PLANTER CURB TO REMAIN. PROTECT IN PLACE.
  - PROPOSED CONCRETE PLANTER CURB TO REMAIN. PROTECT IN PLACE. MATCH FLUSH WITH ADJACENT CONCRETE CURB TO REMAIN. SEE DETAIL 6, SHEET LS-1.0.
  - TRAFFIC SIGNAL COLUMN. PROTECT IN PLACE.
  - PROPOSED FLAGPOLES. SEE DETAIL 9, SHEET LS-10.0.
  - EXISTING UTILITY VAULT.
  - RECYCLING / WASTE CONTAINER. SEE DETAIL 7, SHEET LS-10.0.
  - BIKE RACK. SEE DETAIL 7, SHEET LS-10.0.
  - NEWS RACK. SEE DETAIL 5, SHEET LS-10.0.
  - FREE STANDING PLANTER. SEE DETAIL 4, SHEET LS-10.0.
  - BENCHES. SEE DETAIL 8, SHEET LS-10.0.
  - KIOSK. SEE DETAIL 6, SHEET LS-10.0.
  - TRANSIT SHELTER. SEE DETAIL 4, SHEET LS-10.0.
  - PURGING MARKER. SEE DETAIL 9, SHEET LS-1.0.
  - ISLAND AND DISPLAY PARKING STATION. SEE DETAIL 3, SHEET LS-11.0.
  - EMBEDDED METAL BOLLARD. SEE DETAIL 1, SHEET LS-11.0.
  - REMOVABLE METAL BOLLARD. SEE DETAIL 2, SHEET LS-11.0.
  - ORNAMENTAL RAIN GARDEN FENCE. SEE DETAIL 3, SHEET LS-11.0.
  - RAIN GARDEN CURB INLET AND ORNAMENTAL GRATE. SEE DETAILS 1 & 3, SHEET LS-9.0.
  - RELOCATED HISTORIC SIGN.
  - RELOCATED WEATHER STATION POLE.
  - RELOCATED MAILBOXES.
  - GREEN SCREEN PLANTING WALL.

