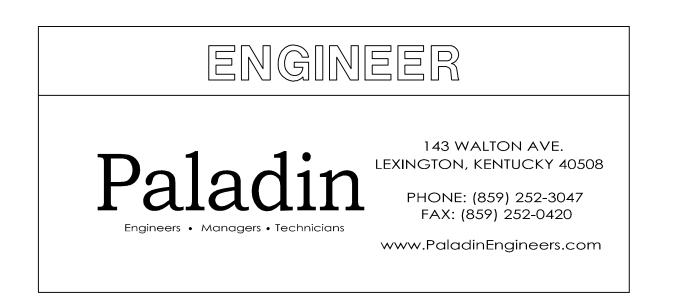
LEXINGTON FAYETTE URBAN COUNTY GOVERNMENT

BLACK & WILLIAMS COMMUNITY CENTER ADULT SERVICES DIVISION 498 GEORGETOWN ST. LEXINGTON, KENTUCKY


SEPTEMBER, 2011



DR	AWING INDEX
Sheet Number	Sheet Title
G1.0	COVER SHEET
D1.0	BASEMENT DEMO PLAN
D1.1	FIRST FLOOR DEMO PLAN
D1.2	SECOND FLOOR DEMO PLAN
M1.0	BASEMENT MECH PLAN
M1.1	FIRST FLOOR MECH PLAN
M1.2	SECOND FLOOR MECH PLAN
M1.3	GYM MECH PLAN
M6.1	MECH SCHEDULES
E1.0	BASEMENT ELECT PLAN
E1.1	FIRST FLOOR ELECT PLAN
E1.2	SECOND FLOOR ELECT PLAN
E1.3	GYM ELECT PLAN
E7.1	ELECTRICAL ONE LINE DIAGRAM

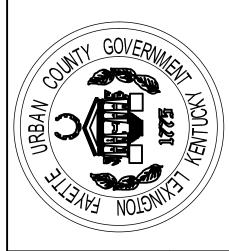PALADIN INC. 143 WALTON AVE. XINGTON, KENTUCKY 40508 PHONE: (859) 252-3047 FAX: (859) 252-0420





an County Government

I Williams

Ses Division

Adult Serv 498 George ver Sheet

APPROVED BY:
MRB

DATE:
1-10-2011

DRAWN BY:

CHECKED BY:
MRB
REVISION:
9/1/11 BID DOCUMENT
WORK ORDER NO.

SHEET NO:

G1.0

CRAWLSPACE

BASEMENT MECHANICAL DEMO PLAN SCALE: 3/16" = 1'-0"

JILER ROOM 368 S.F.

BOOKER STREET

Sheet Tagged Notes

1. DEMO WATER TANK AND ASSOCIATED PIPING IN THIS AREA. DOMESTIC HOT WATER HEATER, SUMP PUMP, AND ASSOCIATED PIPING TO REMAIN.

- 2. DEMO LOW VOLTAGE PANEL IN THIS LOCATION. DEMO ELECTRICAL CIRCUITS BACK TO FEED PANEL. 3. DEMO STEAM UNIT HEATER, ASSOCIATED PIPING AND ELECTRICAL CIRCUIT. WIRING AND CONDUIT SHALL BE DEMO'D TO SOURCE.
- 4. DEMO THERMOSTAT AND CONTROLS WIRING BACK TO SOURCE.
- 5. DEMO STEAM BOILER, PIPING, FITTINGS AND ELECTRICAL CIRCUITS. SALVAGE WATER TREATMENT SYSTEM AND RETURN TO OWNER. OFFER STEAM BOILER TO OWNER FOR REUSE.
- 6. DEMO STEAM HEAT EXCHANGERS, PIPING AND FITTING AT THIS LOCATION. LIMIT WORK TO ACCESSIBLE AREAS. CAP ANY OPEN PIPE. SUMP PUMP AND PIPING TO REMAIN.
- 7. LOUVER AT THIS LOCATION TO REMAIN. SEAL FROM INTERIOR WITH 3/4" MDO EXTERIOR PLYWOOD (PAINTED TO MATCH), 8" BATT INSULATION, AND 3/4" MDO INTERIOR PLYWOOD.
- COMPLETE PANES OF GLASS THAT CONTAINED THE A/C UNITS. REPLACE THE GLASS PANES WITH MATCHING SAFETY WIRE GLASS OF SAME THICKNESS AND TINT AS THAT REMOVED.
- 9. DEMO CONDUIT & WIRING ON THIS WALL TO MAKE SPACE FOR NEW ELECTRICAL PANEL. ALSO
- A. PIPING, FITTINGS AND CONTROL WIRING ASSOCIATED WITH EQUIPMENT TO BE DEMO'D SHALL ALSO BE DEMO'D IF ACCESSIBLE. INACCESSIBLE PIPING SHALL BE DRAINED AND CAPPED.
- IN SAFE MANNER. WHERE ELECTRICAL IS NOT TO BE REUSED, DEMO BACK TO SOURCE AND UPDATE
- F. WHERE CEILING GRID MUST BE REMOVED OR IS DAMAGED AS A RESULT OF DEMO OR NEW WORK (IN PART OF IN FULL) THE ENTIRETY OF THE GRID IN THAT ROOM SHALL BE REPLACED INCLUDING NEW TILES TO MATCH EXISTING. WHERE EXISTING TILES MUST BE REMOVED TO ALLOW FOR DEMO OR NEW WORK, CONTRACTOR SHALL STORE AND PROTECT TILES, OR WHEN DAMAGED REPLACE WITH NEW

G. AREAS WITH HAZARDOUS MATERIALS HAVE BEEN INDICATED BY OWNER ON SIGHT WITH SIGNAGE. DO NOT ENTER THESE AREAS WITH OUT AUTHORIZATION FROM THE OWNER AND PROPER WORKER PROTECTION EQUIPMENT. CONTRACTORS WHO DO ENTER THESE AREAS SHALL BE ASBESTOS CERTIFIED.

GRIND SURFACE SMOOTH TO MATCH LEVEL OF SURROUNDING CONCRETE. PATCH FLOOR TILE TO CLOSELY MATCH EXISTING BY REPLACING WHOLE TILES. REPAIR HOLES IN WOOD FLOORS AS FOLLOWS. REMOVE SECTIONS FINISH FLOOR AND SUBSTRATE FROM JOIST CENTERLINE TO JOIST CENTERLINE. REPLACE SUBSTRATE WITH INTERIOR A/B GRADE

PLYWOOD. REPLACE FINISH WOOD FLOORING WITH SPECIES, GRADE, AND WIDTH TO CLOSELY MATCH EXISTING. FINISH WOOD FLOORING TO BE REPLACED IN STRIPS NOT SHORTER THAN 164. SAND SMOOTH, AND THEN STAIN AND FINISH AS NECESSARY TO CLOSELY MATCH THE EXISTING REPAIR HOLES IN CONCRETE BLOCK WALLS AS FOLLOWS. SAW-CUT ENTIRE BLOCK UNIT,

CONTAINING THE HOLE, AT THE JOINTS AND REPLACE THE UNIT WITH A MATCHING STANDARD WEIGHT CONCRETE BLOCK OF SAME SIZE AND SIMILAR FINISH. TOOL JOINTS TO MATCH EXISTING. REPAINT COMPLETE AREA BEHIND REMOVED RADIANT HEATERS WITH LATEX PAINT TO MATCH EXISTING IN COLOR AND FINISH. FEATHER EDGES TO AVOID LINES BETWEEN NEW AND OLD PAINT. NTY GOVERNAL


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SCALE: 3/16" = 1-0"





APPROVED BY: MRB 1-10-2011 DRAWN BY:

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SHEET NO:

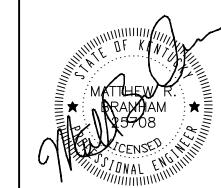1. DEMO STEAM RADIATOR AND ASSOCIATED PIPING / FITTINGS THIS LOCATION.

2. DEMO THERMOSTAT AND CONTROLS WIRING THIS LOCATION.

3. DEMO WINDOW MOUNTED PTAC UNIT. OFFER TO OWNER FOR REUSE. REMOVE THE COMPLETE PANES OF GLASS THAT CONTAINED THE A/C UNITS. REPLACE THE GLASS PANES WITH MATCHING SAFETY WIRE GLASS OF SAME THICKNESS AND TINT AS THAT REMOVED.

4. CAP CHIMNEY ON ROOF ABOVE PER CHIMNEY CAP DETAIL ON SHEET M6.1.

General Notes

A. PIPING, FITTINGS AND CONTROL WIRING ASSOCIATED WITH EQUIPMENT TO BE DEMO'D SHALL ALSO BE DEMO'D IF ACCESSIBLE. INACCESSIBLE PIPING SHALL BE DRAINED AND CAPPED.

B. COORDINATE DEMO WORK WITH NEW WORK.

PANEL DIRECTORIES. E. FIELD VERIFY ALL EXISTING CONDITIONS BEFORE BID DATE.

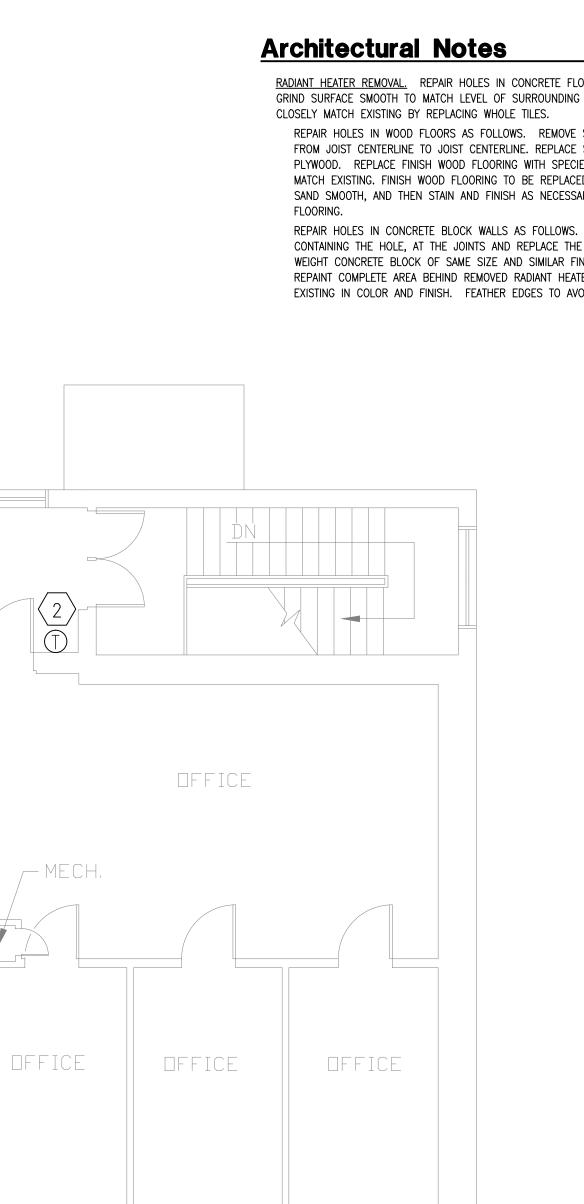
F. WHERE CEILING GRID MUST BE REMOVED OR IS DAMAGED AS A RESULT OF DEMO OR NEW WORK (IN PART OF IN FULL) THE ENTIRETY OF THE GRID IN THAT ROOM SHALL BE REPLACED INCLUDING NEW TILES TO MATCH EXISTING. WHERE EXISTING TILES MUST BE REMOVED TO ALLOW FOR DEMO OR NEW WORK, CONTRACTOR SHALL STORE AND PROTECT TILES, OR WHEN DAMAGED REPLACE WITH NEW TILES TO MATCH EXISTING.

G. AREAS WITH HAZARDOUS MATERIALS HAVE BEEN INDICATED BY OWNER ON SIGHT WITH SIGNAGE. DO NOT ENTER THESE AREAS WITH OUT AUTHORIZATION FROM THE OWNER AND PROPER WORKER

RADIANT HEATER REMOVAL. REPAIR HOLES IN CONCRETE FLOORS WITH 4,000 PSI CONCRETE PLUGS. GRIND SURFACE SMOOTH TO MATCH LEVEL OF SURROUNDING CONCRETE. PATCH FLOOR TILE TO

FROM JOIST CENTERLINE TO JOIST CENTERLINE. REPLACE SUBSTRATE WITH INTERIOR A/B GRADE PLYWOOD. REPLACE FINISH WOOD FLOORING WITH SPECIES, GRADE, AND WIDTH TO CLOSELY MATCH EXISTING. FINISH WOOD FLOORING TO BE REPLACED IN STRIPS NOT SHORTER THAN 164. SAND SMOOTH, AND THEN STAIN AND FINISH AS NECESSARY TO CLOSELY MATCH THE EXISTING FLOORING.

REPAIR HOLES IN CONCRETE BLOCK WALLS AS FOLLOWS. SAW-CUT ENTIRE BLOCK UNIT, CONTAINING THE HOLE, AT THE JOINTS AND REPLACE THE UNIT WITH A MATCHING STANDARD WEIGHT CONCRETE BLOCK OF SAME SIZE AND SIMILAR FINISH. TOOL JOINTS TO MATCH EXISTING. REPAINT COMPLETE AREA BEHIND REMOVED RADIANT HEATERS WITH LATEX PAINT TO MATCH EXISTING IN COLOR AND FINISH. FEATHER EDGES TO AVOID LINES BETWEEN NEW AND OLD PAINT.



SECOND FLOOR MECHANICAL DEMO PLAN SCALE: 3/16" = 1'-0"

DFFICE

OFFICE

OFFICE

MECH. —

OFFICE

OFFICE

TRAINING

CORRIDOR

OFFICE

OFFICE

DFFICE

DFFICE

BREAK ROOM

STORAGE

CORRIDOR

OFFICE

STUDIO

OFFICE

RECEPTION

ENTRY

\ DFFICE

OFFICE

OFFICE

RECEPTION

OFFICE

OFFICE

OFFICE

OFFICE

CLOSET —

CORRIDOR

DFFICE

OFFICE

OFFICE

OFFICE



WORK ORDER NO. SHEET NO:

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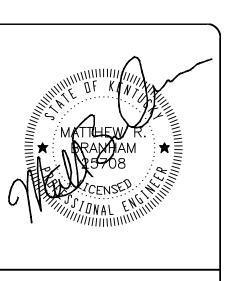
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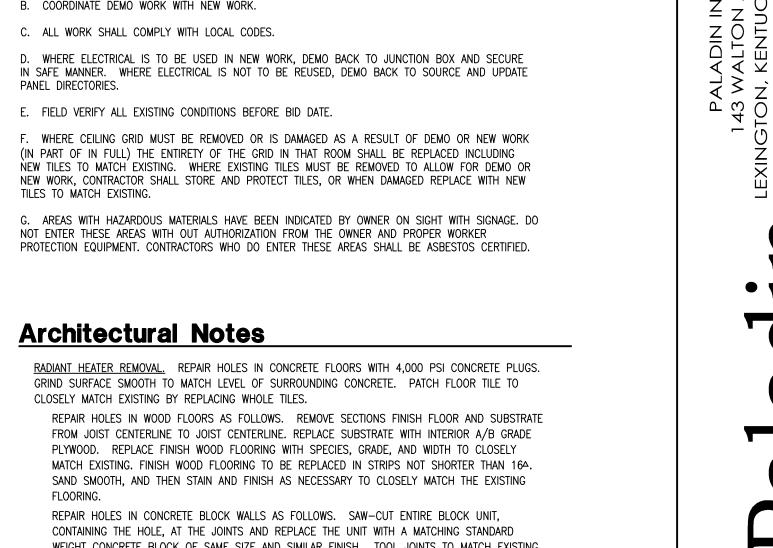
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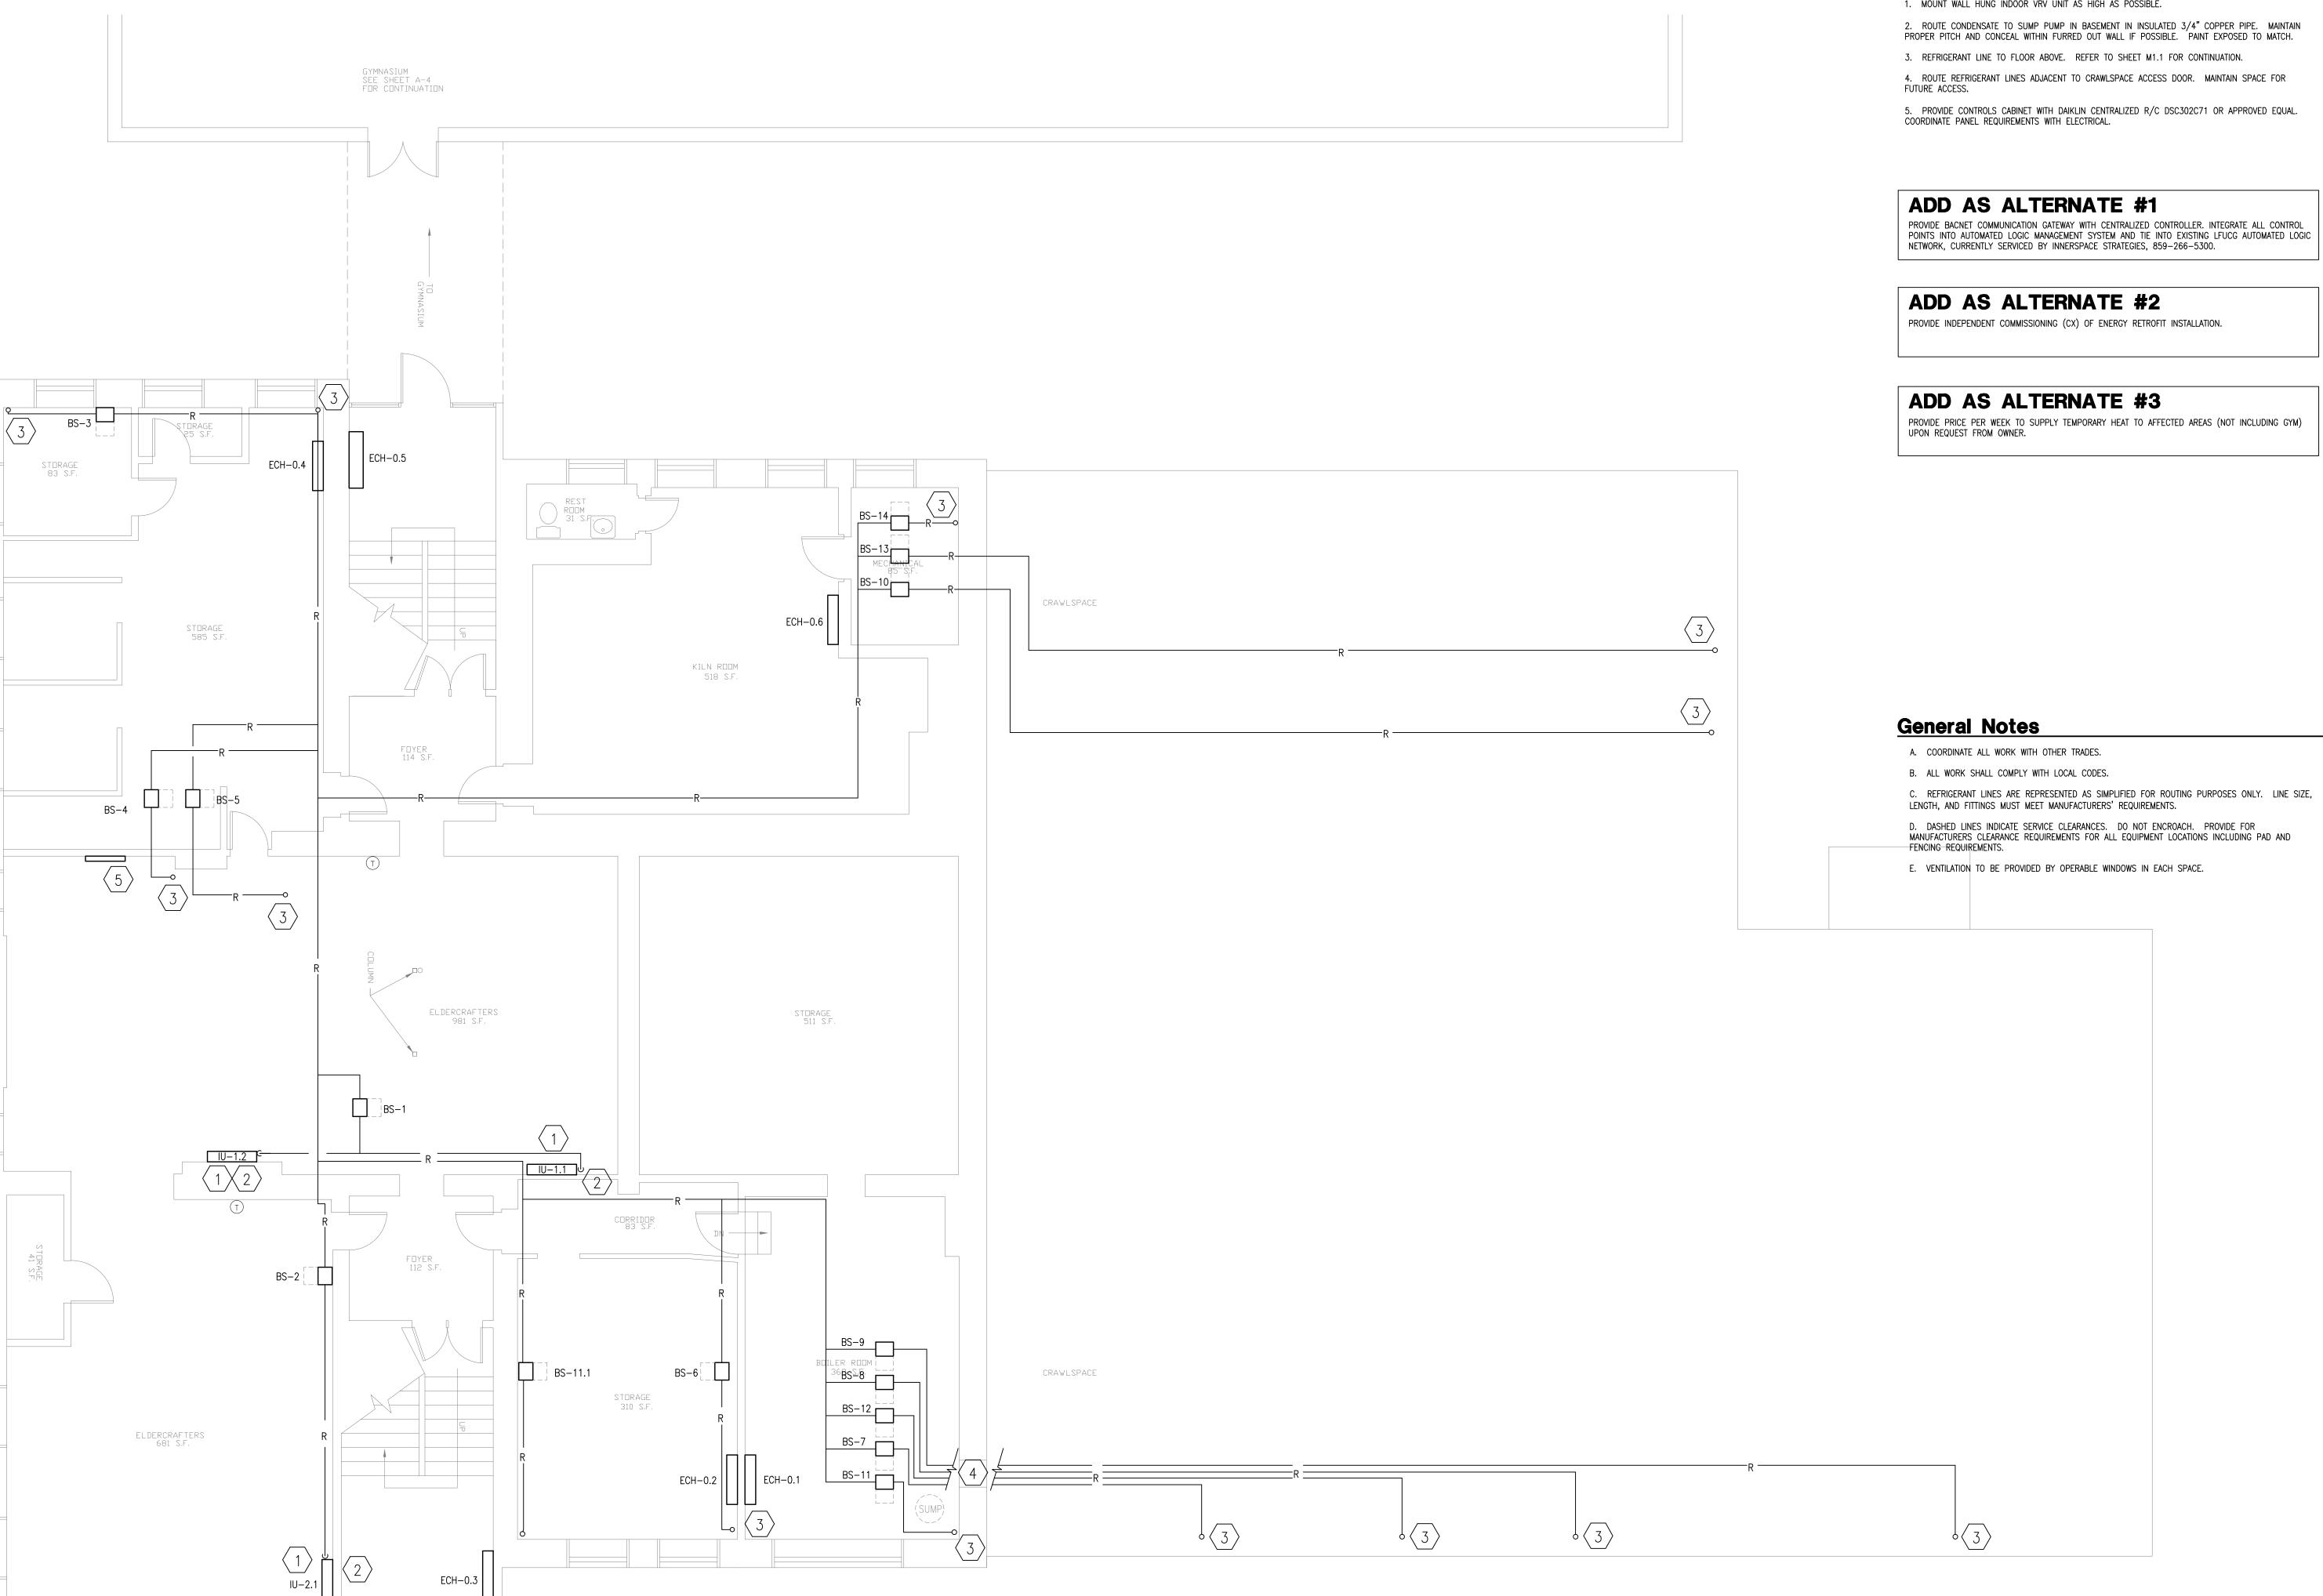
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BOOKER STREET

BASEMENT MECHANICAL PLAN SCALE: 3/16" = 1'-0"



1. MOUNT WALL HUNG INDOOR VRV UNIT AS HIGH AS POSSIBLE.

2. ROUTE CONDENSATE TO SUMP PUMP IN BASEMENT IN INSULATED 3/4" COPPER PIPE. MAINTAIN PROPER PITCH AND CONCEAL WITHIN FURRED OUT WALL IF POSSIBLE. PAINT EXPOSED TO MATCH. 3. REFRIGERANT LINE TO FLOOR ABOVE. REFER TO SHEET M1.1 FOR CONTINUATION.

PROVIDE INDEPENDENT COMMISSIONING (CX) OF ENERGY RETROFIT INSTALLATION.

PROVIDE PRICE PER WEEK TO SUPPLY TEMPORARY HEAT TO AFFECTED AREAS (NOT INCLUDING GYM) UPON REQUEST FROM OWNER.

C. REFRIGERANT LINES ARE REPRESENTED AS SIMPLIFIED FOR ROUTING PURPOSES ONLY. LINE SIZE, LENGTH, AND FITTINGS MUST MEET MANUFACTURERS' REQUIREMENTS.

D. DASHED LINES INDICATE SERVICE CLEARANCES. DO NOT ENCROACH. PROVIDE FOR MANUFACTURERS CLEARANCE REQUIREMENTS FOR ALL EQUIPMENT LOCATIONS INCLUDING PAD AND FENCING REQUIREMENTS.



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FIRST FLOOR MECHANICAL PLAN SCALE: 3/16" = 1'-0"

4

4

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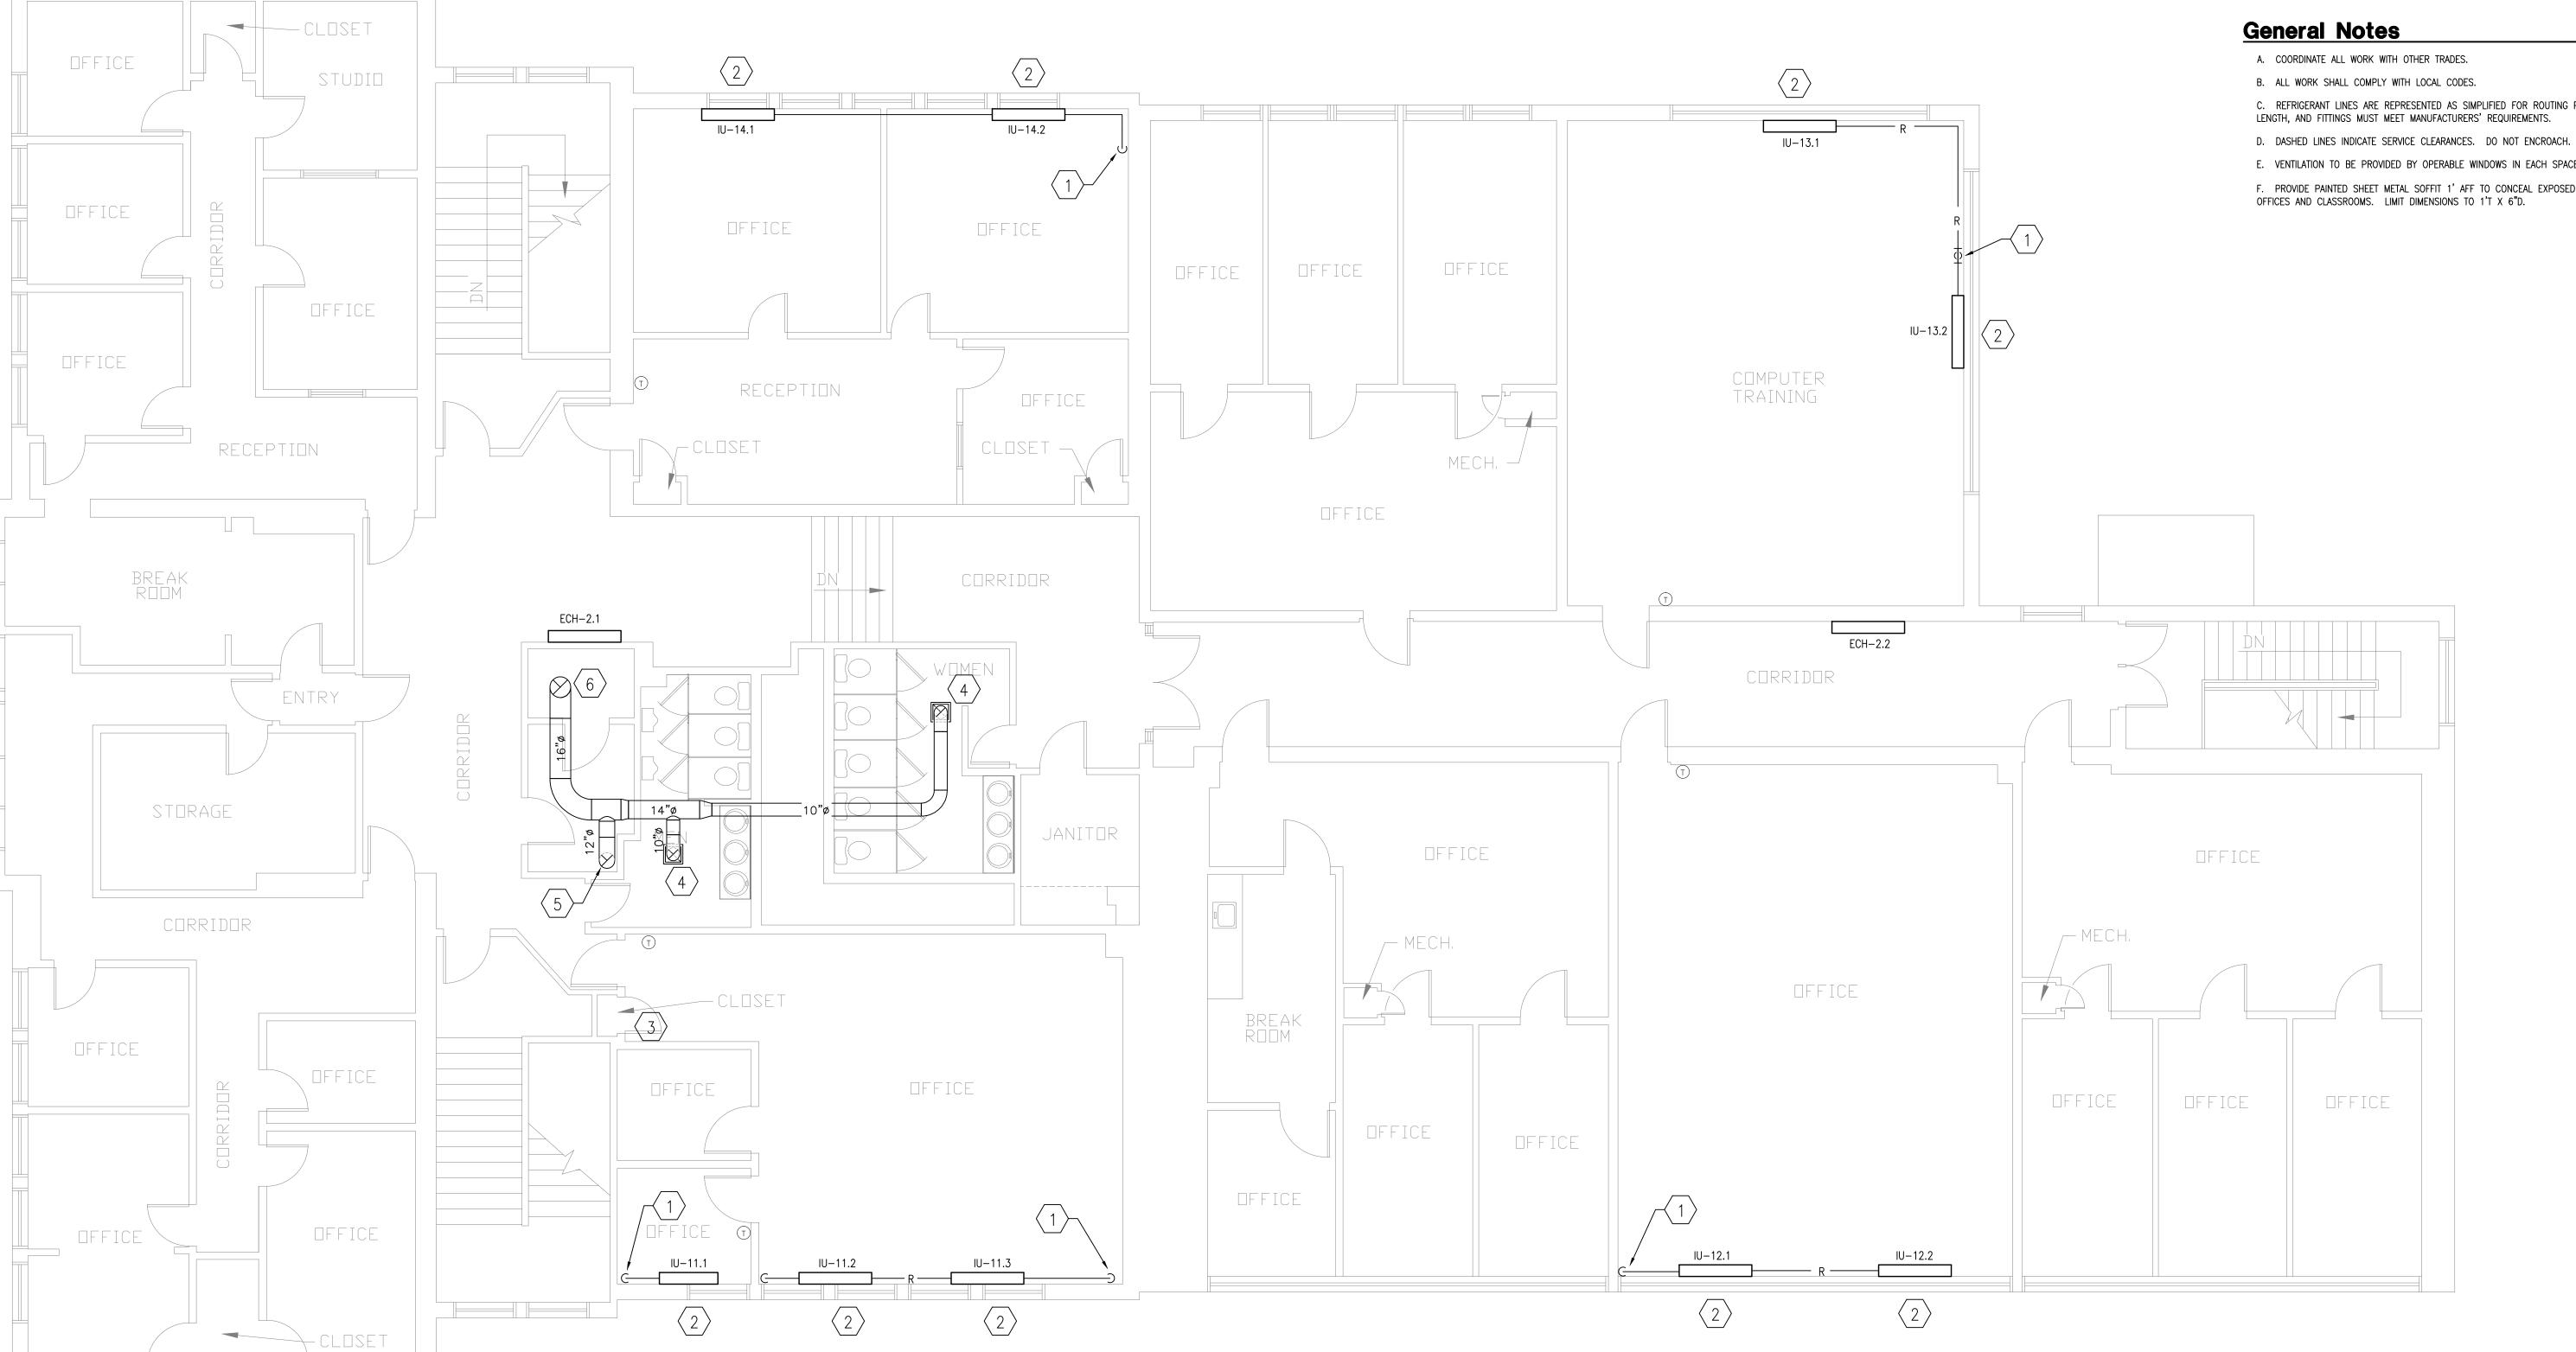
3. PROVIDE TWO (2) 10"x4" TRANSFER GRILLES IN EXISTING SOLID DOOR, ONE HIGH ONE LOW, EQUAL TO PRICE STG SERIES. INTENDED TO PROVIDE AIR CIRCULATION THROUGH SERVER CLOSET. 4. CONNECT NEW DUCTWORK TO EXISTING BATHROOM EXHAUST FAN AT LOCATION SHOWN. ALL DUCT SHALL BE CONCEALED ABOVE DROP CEILING.

5. PROVIDE 12" ROUND DUCT FROM FIRST FLOOR. REFER TO SHEET M1.1.

6. PROVIDE 16" ROUND DUCT TO EXISTING GENERAL EXHAUST HOOD ABOVE THIS LOCATION ON ROOF.

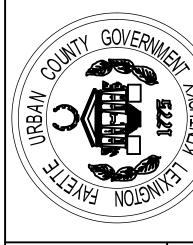
- A. COORDINATE ALL WORK WITH OTHER TRADES.
- C. REFRIGERANT LINES ARE REPRESENTED AS SIMPLIFIED FOR ROUTING PURPOSES ONLY. LINE SIZE, LENGTH, AND FITTINGS MUST MEET MANUFACTURERS' REQUIREMENTS.
- E. VENTILATION TO BE PROVIDED BY OPERABLE WINDOWS IN EACH SPACE.

F. PROVIDE PAINTED SHEET METAL SOFFIT 1' AFF TO CONCEAL EXPOSED REFRIGERANT LINES IN OFFICES AND CLASSROOMS. LIMIT DIMENSIONS TO 1'T X 6"D.



SECOND FLOOR MECHANICAL PLAN
SCALE: 3/16" = 1'-0"





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Sheet Tagged Notes

1. REFER TO SHEET M1.1 FOR CONTINUATION

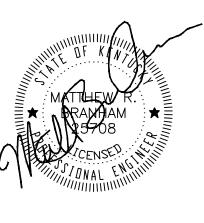
2. RUN REFRIGERANT LINES ABOVE ROOF OF BREEZEWAY CONNECTING MAIN BUILDING AND GYM. PROVIDE 12"Wx8"T 12GA STAINLESS STEEL ENCLOSURE AROUND INSULATED REFRIGERANT LINES. ENCLOSURE SHALL BE SECURED TO ROOF OF BREEZEWAY AND SHALL BE CONTINUOUS FROM CHAIN—LINK CONDENSER ENCLOSURE TO WALL PENETRATION.

3. PROVIDE CHAIN LINK ENCLOSURE COMPLETE WITH CHAIN LINK COVER TO PROTECT CONDENSING UNITS PER MANUFACTURERS CLEARANCE REQUIREMENTS. ENCLOSURE SHALL BE 8' TALL. PROVIDE LOCKABLE GATE ADEQUATELY SIZED FOR SERVICE AND REMOVAL, ON PLAN EAST SECTION OF FENCING. MAINTAIN PROPER SERVICE CLEARANCES AND AVOID BLOCKING RAMP TO BASEMENT MECHANICAL ROOM. SUBMIT SHOP DRAWINGS FOR APPROVAL. PROTECT REFRIGERANT LINES AT GROUND LEVEL WITHIN

4. OUTDOOR CONDENSING UNITS SHALL BE INSTALLED ON 4" CONCRETE PADS. COORDINATE EXACT LOCATION AND DIMENSIONS WITH MANUFACTURERS REQUIREMENTS.

General Notes

- A. COORDINATE ALL WORK WITH OTHER TRADES.
- B. ALL WORK SHALL COMPLY WITH LOCAL CODES.
- C. REFRIGERANT LINES ARE REPRESENTED AS SIMPLIFIED FOR ROUTING PURPOSES ONLY. LINE SIZE, LENGTH, AND FITTINGS MUST MEET MANUFACTURERS' REQUIREMENTS.
- D. DASHED LINES INDICATE SERVICE CLEARANCES. DO NOT ENCROACH.





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WORK ORDER NO.

SHEET NO:



		CAB	INET UNIT HE	ATER SCHE	DULE		
MARK	MANUFACTURER	MODEL	LENGTH	KW	V / φ / Hz	FLA / MCA	NOTES
ECH-0.1	QMARK	AWH-3150	_	1.5	120/1/60	12.5	1,3,4,5
ECH-0.2	QMARK	AWH-3150	_	1.5	120/1/60	12.5	1,3,4,5
ECH-0.3	QMARK	AWH-4404	-	4	240/1/60	16.7	1,2,3,4,5
ECH-0.4	QMARK	AWH-4404	-	2	240/1/60	8.3	1,2,3,4,5
ECH-0.5	QMARK	AWH-4404	_	4	240/1/60	16.7	1,2,3,4,5
ECH-0.6	QMARK	AWH-4404	_	2	240/1/60	8.3	1,2,3,4,5
ECH-1.1	QMARK	AWH-4404	_	4	240/1/60	16.7	1,2,3,4,5
ECH-1.2	QMARK	AWH-3150	-	1.5	120/1/60	12.5	3,4,5
ECH-2.1	QMARK	AWH-3150	_	1.5	120/1/60	12.5	3,4,5
ECH-2.2	QMARK	AWH-3150	-	1.5	120/1/60	12.5	3,4,5

NOTES:	

- SURFACE MOUNTING FRAME.
 14 GA SECURITY FRONT COVER.
- 3. BUILT IN 24 VAC ENERGY MANAGEMENT RELAY.
- 4. BUILT IN DISCONNECT SWITCH.5. BUILT IN THERMOSTAT.


ITEM DESCRIPTION	VALUE
LATITUDE / LONGITUDE	38.0/84.7
ELEVATION	979'-0"
CLEARNESS NUMBER	0.95
SUMMER O.A. DESIGN DRY BULB/WET BULB	93.0/72.0
WINTER O.A. DESIGN DRY BULB	8
COOLING LOAD METHODOLOGY	TETD-TA1
COOLING SETPOINT	75
HEATING SETPOINT	70
COOLING/HEATING SETBACK	81/64
ROOF U-VALUE	0.199
WALL U-VALUE	0.184
GLASS U-VALUE	0.95
GLASS SHADING COEFFICIENT	0.95
OUTDOOR AIR VENTILATION RATE	PER ASHRAE 6:

	VRV HEAT PUMP OUTDOOR UNIT SCHEDULE											
MARK	MANUFACTURER	MODEL	NOMINAL CAPACITY	COOLING CAPACITY	HEATING CAPACITY	V / Ø / Hz	FLA	MCA	NOTES			
0U-1	DAIKIN	REYQ240PTJUR	240,000	201,727	162,165	208/3/60	41.3/41.3	60/60	1,2,3,4,5,6			
0U-2	DAIKIN	REYQ240PTJUR	240,000	201,727	162,165	208/3/60	41.3/41.3	60/60	1,2,3,4,5,6			
0U-3	DAIKIN	REYQ120PATJ	120,000	111,568	81,538	208/3/60	25.6	50	1,2,3,4,5,6			


- 1. COOLING PERFORMANCE BASED ON THE FOLLOWING CONDITIONS; INDOOR DB/WB: 72°F/62.6°F, OUTDOOR DB: 95°F, PIPE LENGTH: 25FT, LEVEL DIFFERENCE: OFT 2. HEATING PERFORMANCE BASED ON THE FOLLOWING CONDITIONS; INDOOR DB: 68°F, OUTDOOR DB: 6.1°F, PIPE LENGTH: 25FT, LEVEL DIFFERENCE: OFT
- 3. PROVIDE COATED CORROSION RESISTANT CONDENSER COILS.
- 4. PROVIDE INTERNAL GROUND—FAULT CIRCUIT BREAKER.
 5. PROVIDE VFD CONTROLLED OUTDOOR FAN MOTORS AND VARIABLE SPEED COMPRESSOR
- 5. PROVIDE VFD CONTROLLED OUTDOOR FAN MOTORS AND VARIABLE SPEED COMPRESSORS.6. PROVIDE OUTDOOR UNIT MULTI-CONNECTION PIPE KIT MANIFOLD.

				COOLING	CAPACITY	HEATING CAPACITY					
MARK MANUFACTURER	MANUFACTURER	MODEL	STYLE	TOTAL (BTUH)	SENSIBLE (BTUH)	(BTUH)	CFM	V / Ø / Hz	FLA	MCA	NOTES
IU-1.1	DAIKIN	FXAQ18MVJU	WALL MOUNT	13768	9844	12162	400-500	230/1/60	15	0.4	1,2,3,4,5,6
IU-1.2	DAIKIN	FXAQ18MVJU	WALL MOUNT	13617	9780	12162	400-500	230/1/60	15	0.4	1,2,3,4,5,
IU-2.1	DAIKIN	FXAQ24MVJU	WALL MOUNT	18004	12668	16217	470-634	230/1/60	15	0.6	1,2,3,4,5,
IU-3.1	DAIKIN	FXLQ18MVJU	FLOOR CONSOLE	14186	9411	12162	380-490	230/1/60	15	0.6	1,2,3,4,5,
IU-3.2	DAIKIN	FXLQ18MVJU	FLOOR CONSOLE	14133	9387	12162	380-490	230/1/60	15	0.6	1,2,3,4,5,
IU-4.1	DAIKIN	FXTQ48PAVJU	VERTICAL AHU	37260	24627	32433	1120-1600	230/1/60	15	5	1,2,3,4,5,
IU-5.1	DAIKIN	FXTQ48PAVJU	VERTICAL AHU	37616	24782	32433	1120-1600	230/1/60	15	5	1,2,3,4,5,
IU-6.1	DAIKIN	FXLQ24MVJU	FLOOR CONSOLE	18199	11936	14825	420-560	230/1/60	15	0.6	1,2,3,4,5,
IU-6.2	DAIKIN	FXLQ24MVJU	FLOOR CONSOLE	18199	11936	14825	420-560	230/1/60	15	0.6	1,2,3,4,5
IU-7.1	DAIKIN	FXLQ24MVJU	FLOOR CONSOLE	17938	11821	14825	420-560	230/1/60	15	0.6	1,2,3,4,5,
IU-7.2	DAIKIN	FXLQ24MVJU	FLOOR CONSOLE	17938	11821	14825	420-560	230/1/60	15	0.6	1,2,3,4,5,
IU-8.1	DAIKIN	FXLQ24MVJU	FLOOR CONSOLE	17377	11576	16217	420-560	230/1/60	15	0.6	1,2,3,4,5,
IU-8.2	DAIKIN	FXLQ24MVJU	FLOOR CONSOLE	17377	11576	16217	420-560	230/1/60	15	0.6	1,2,3,4,5,
IU-9.1	DAIKIN	FXLQ24MVJU	FLOOR CONSOLE	17147	11474	16217	420-560	230/1/60	15	0.6	1,2,3,4,5,
IU-9.2	DAIKIN	FXLQ24MVJU	FLOOR CONSOLE	17147	11474	16217	420-560	230/1/60	15	0.6	1,2,3,4,5,
IU-10.1	DAIKIN	FXTQ48PAVJU	VERTICAL AHU	34445	23393	32433	1120-1600	230/1/60	15	5	1,2,3,4,5,
IU-11.1	DAIKIN	FXLQ12MVJU	FLOOR CONSOLE	8732	5871	8108	210-280	230/1/60	15	0.5	1,2,3,4,5,
IU-11.2	DAIKIN	FXLQ18MVJU	FLOOR CONSOLE	13055	8917	12162	380-490	230/1/60	15	0.6	1,2,3,4,5,
IU-11.3	DAIKIN	FXLQ18MVJU	FLOOR CONSOLE	13033	8907	12162	380-490	230/1/60	15	0.6	1,2,3,4,5,
IU-12.1	DAIKIN	FXLQ24MVJU	FLOOR CONSOLE	17349	11562	16217	420-560	230/1/60	15	0.6	1,2,3,4,5,
IU-12.2	DAIKIN	FXLQ24MVJU	FLOOR CONSOLE	17781	11752	16217	420-560	230/1/60	15	0.6	1,2,3,4,5,
IU-13.1	DAIKIN	FXLQ24MVJU	FLOOR CONSOLE	16945	11386	16217	420-560	230/1/60	15	0.6	1,2,3,4,5,
IU-13.2	DAIKIN	FXLQ24MVJU	FLOOR CONSOLE	16970	11397	16217	420-560	230/1/60	15	0.6	1,2,3,4,5,
IU-14.1	DAIKIN	FXLQ18MVJU	FLOOR CONSOLE	13562	9139	11119	380-490	230/1/60	15	0.6	1,2,3,4,5,

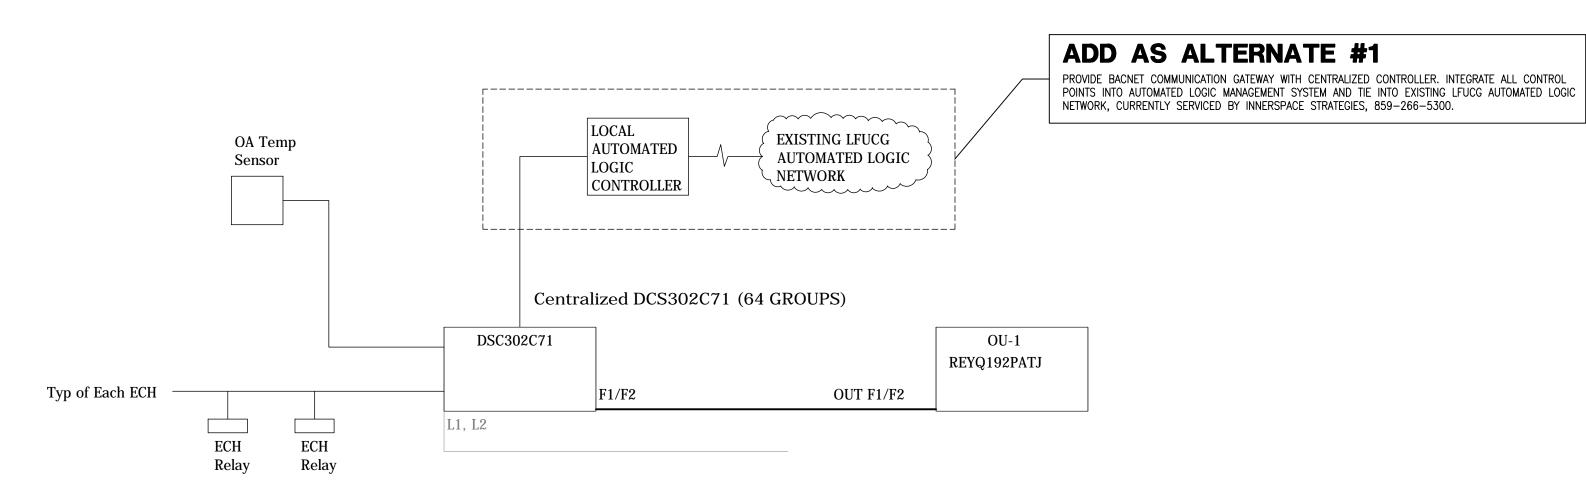- 1. COOLING PERFORMANCE BASED ON THE FOLLOWING CONDITIONS; INDOOR DB/WB: 72°F/62.6°F, OUTDOOR DB: 95°F, PIPE LENGTH: 25FT, LEVEL DIFFERENCE: OFT 2. HEATING PERFORMANCE BASED ON THE FOLLOWING CONDITIONS; INDOOR DB: 68°F, OUTDOOR DB: 6.1°F, PIPE LENGTH: 25FT, LEVEL DIFFERENCE: OFT
- 3. COORDINATE INSTALLATION WITH MANUFACTURERS REQUIREMENTS.
 4. REFER TO PIPING SCHEMATIC, WIRING SCHEMATIC AND PLANS FOR ADDITIONAL REQUIREMENTS AND INFORMATION.
- PROVIDE SIMPLIFIED WIRED THERMOSTAT MOUNTED WHERE INDICATED ON PLANS.
 PROVIDE CENTRALIZED MULTI-ZONE CONTROLLER WHERE INDICATED ON PLANS. REFER TO CONTROLS WIRING DIAGRAM THIS SHEET.
- 6. PROVIDE CENTRALIZED MULTI-ZONE CONTROLLER WHERE INDICATED ON PLANS. REFER TO CONTROLS WIRING DIAGRAM THIS SHI
 7. PROVIDE FILTER CHAMBER KIT.
- 8. PROVIDE SELF CONTAINED CONDENSATE PUMP KIT.



VRV SYSTEM CENTRALIZED CONTROLLER

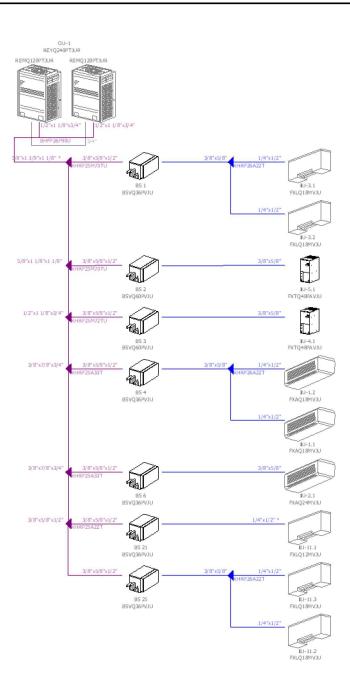


REFRIGERANT PIPING SCHEMATIC OU-1

NOTES:

1. PROVIDE REFNET ENGINEERED FITTINGS (KHRP) AT EACH PIPING BRANCH.

2. SIZED IS BASED ON CONFIGURATION / ROUTING AS DEPICTED IN PLANS. ANY DEVIATION FROM DESIGN WILL BE THE CONTRACTORS RESPONSIBILITY TO COORDINATE WITH LINE SIZES.

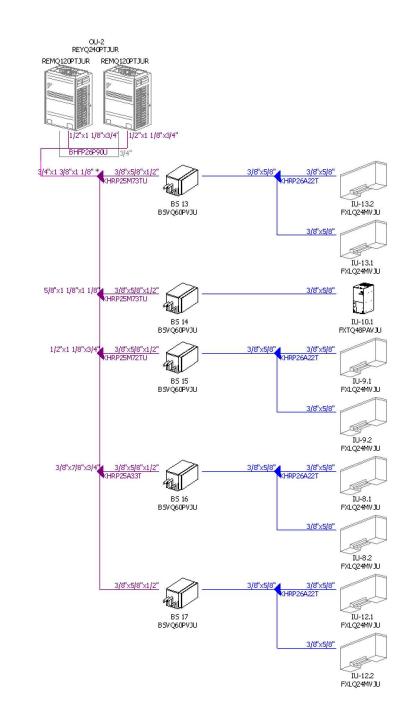3. PROVIDE REFRIGERANT ISOLATION VALVES AT EACH INDOOR UNIT TO PERMIT SERVICES OF EQUIPMENT.




REFRIGERANT PIPING SCHEMATIC OU-2

NOTES:
1. PROVIDE REFNET ENGINEERED FITTINGS (KHRP) AT EACH PIPING BRANCH.


2. SIZED IS BASED ON CONFIGURATION / ROUTING AS DEPICTED IN PLANS. ANY DEVIATION FROM DESIGN WILL BE THE CONTRACTORS RESPONSIBILITY TO COORDINATE WITH LINE SIZES.

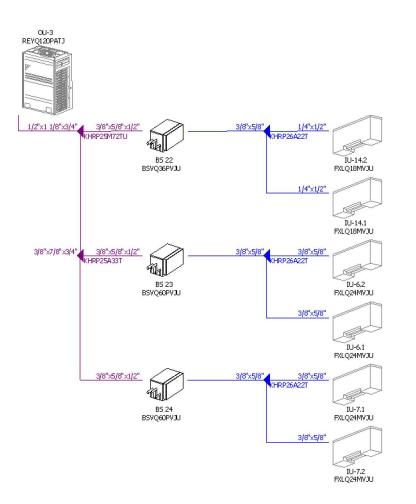3. PROVIDE REFRIGERANT ISOLATION VALVES AT EACH INDOOR UNIT TO PERMIT SERVICES OF EQUIPMENT.




REFRIGERANT PIPING SCHEMATIC OU-3

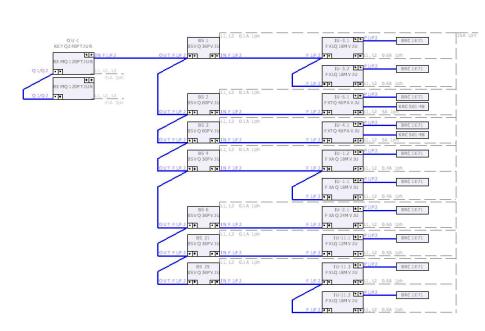
PROVIDE REFNET ENGINEERED FITTINGS (KHRP) AT EACH PIPING BRANCH.
 SIZED IS BASED ON CONFIGURATION / ROUTING AS DEPICTED IN PLANS. ANY DEVIATION FROM DESIGN WILL BE THE CONTRACTORS RESPONSIBILITY TO COORDINATE WITH LINE SIZES.
 PROVIDE REFRIGERANT ISOLATION VALVES AT EACH INDOOR UNIT TO PERMIT SERVICES OF EQUIPMENT.




CONTROL WIRING SCHEMATIC OU-1

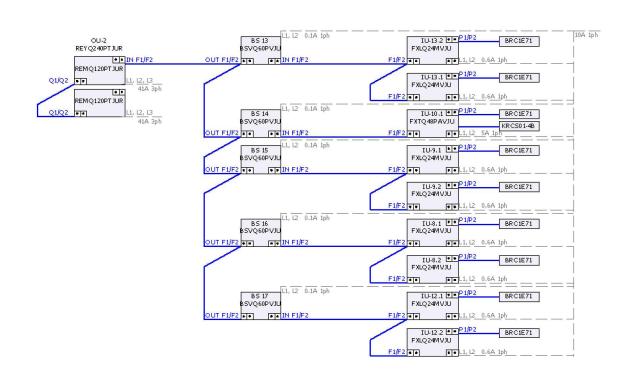



CONTROL WIRING SCHEMATIC OU-2

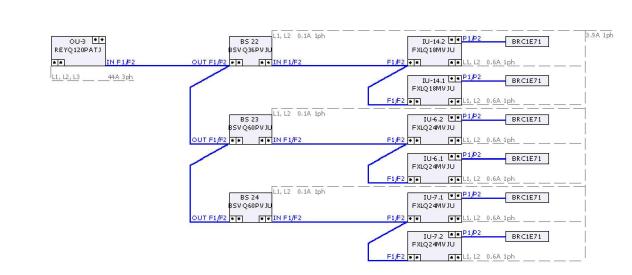


CONTROL WIRING SCHEMATIC OU-3

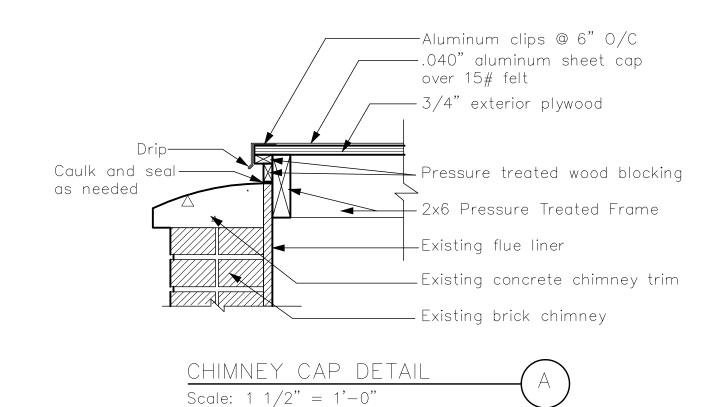

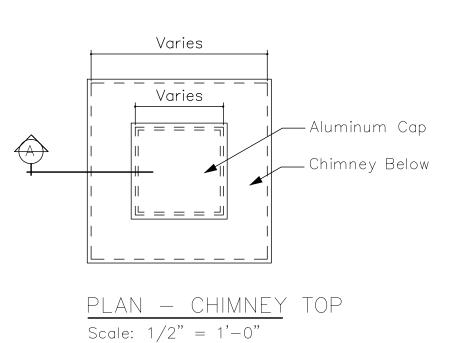

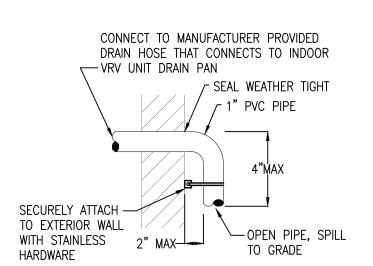

CONDENSATE DRAIN DETAIL
SCALE: NTS

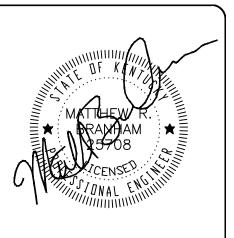

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Pala all all the Engineers • Managers • Technicians



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tte Urban County Governm ack and Williams t Services Division

Black and W Adult Services 498 Georgetow

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DATE:
1-10-2011
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M6.1

BASEMENT ELECTRICAL PLAN
SCALE: 3/16" = 1-0"

BOOKER STREET

Sheet Tagged Notes

1. TAP BUS OF EXISTING 800A MAIN SUB PANEL. WIRE TO BE LESS THAN 25 FEET IN LENGTH. 2. (2) 500 KCMIL CONDUCTORS (1) 500 KCMIL NEUTRAL (1) #2 GROUND; THHN 90°C

3. RESTORE GROUND CONDUCTORS TO EXISTING SUB-PANELS. REMOVE UNUTILIZED WIRE AND COVER EXPOSED COMPONENTS AND OPENINGS IN PANEL.

6. DEMO EXISTING CONDUIT/CIRCUITS SERVING WALL CLOCK. VERIFY CIRCUITS DO NOT FEED OTHER DEVICES PRIOR TO DEMOLITION. CONTACT ENGINEER IF CIRCUITS FEED OTHER DEVICES.

A. ELECTRICAL EQUIPMENT AND INSTALLATION SHALL BE IN ACCORDANCE WITH THE LATEST EDITION OF THE NATIONAL ELECTRIC CODE.

B. PROVIDE LOCAL DISCONNECTING MEANS AS SHOWN AND/OR REQUIRED BY THE N.E.C.

F. 1) WIRE FOR 15 OR 20 AMP CIRCUITS TO BE #12 THHN UNLESS OTHERWISE NOTED.

2) WIRE FOR 30 AMP CIRCUITS TO BE #10 THHN UNLESS OTHERWISE NOTED.

3) ALL 20 OR 30 AMP CIRCUITS GREATER THAN 100 FEET IN LENGTH SHALL BE INCREASED TO NEXT STANDARD WIRE SIZE.



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SHEET NO:

1. REUSE EXISTING 230V CIRCUIT. VERIFY CIRCUIT IS DEDICATED TO THIS EXISTING OUTLET. IF NOT CONTACT ENGINEER.

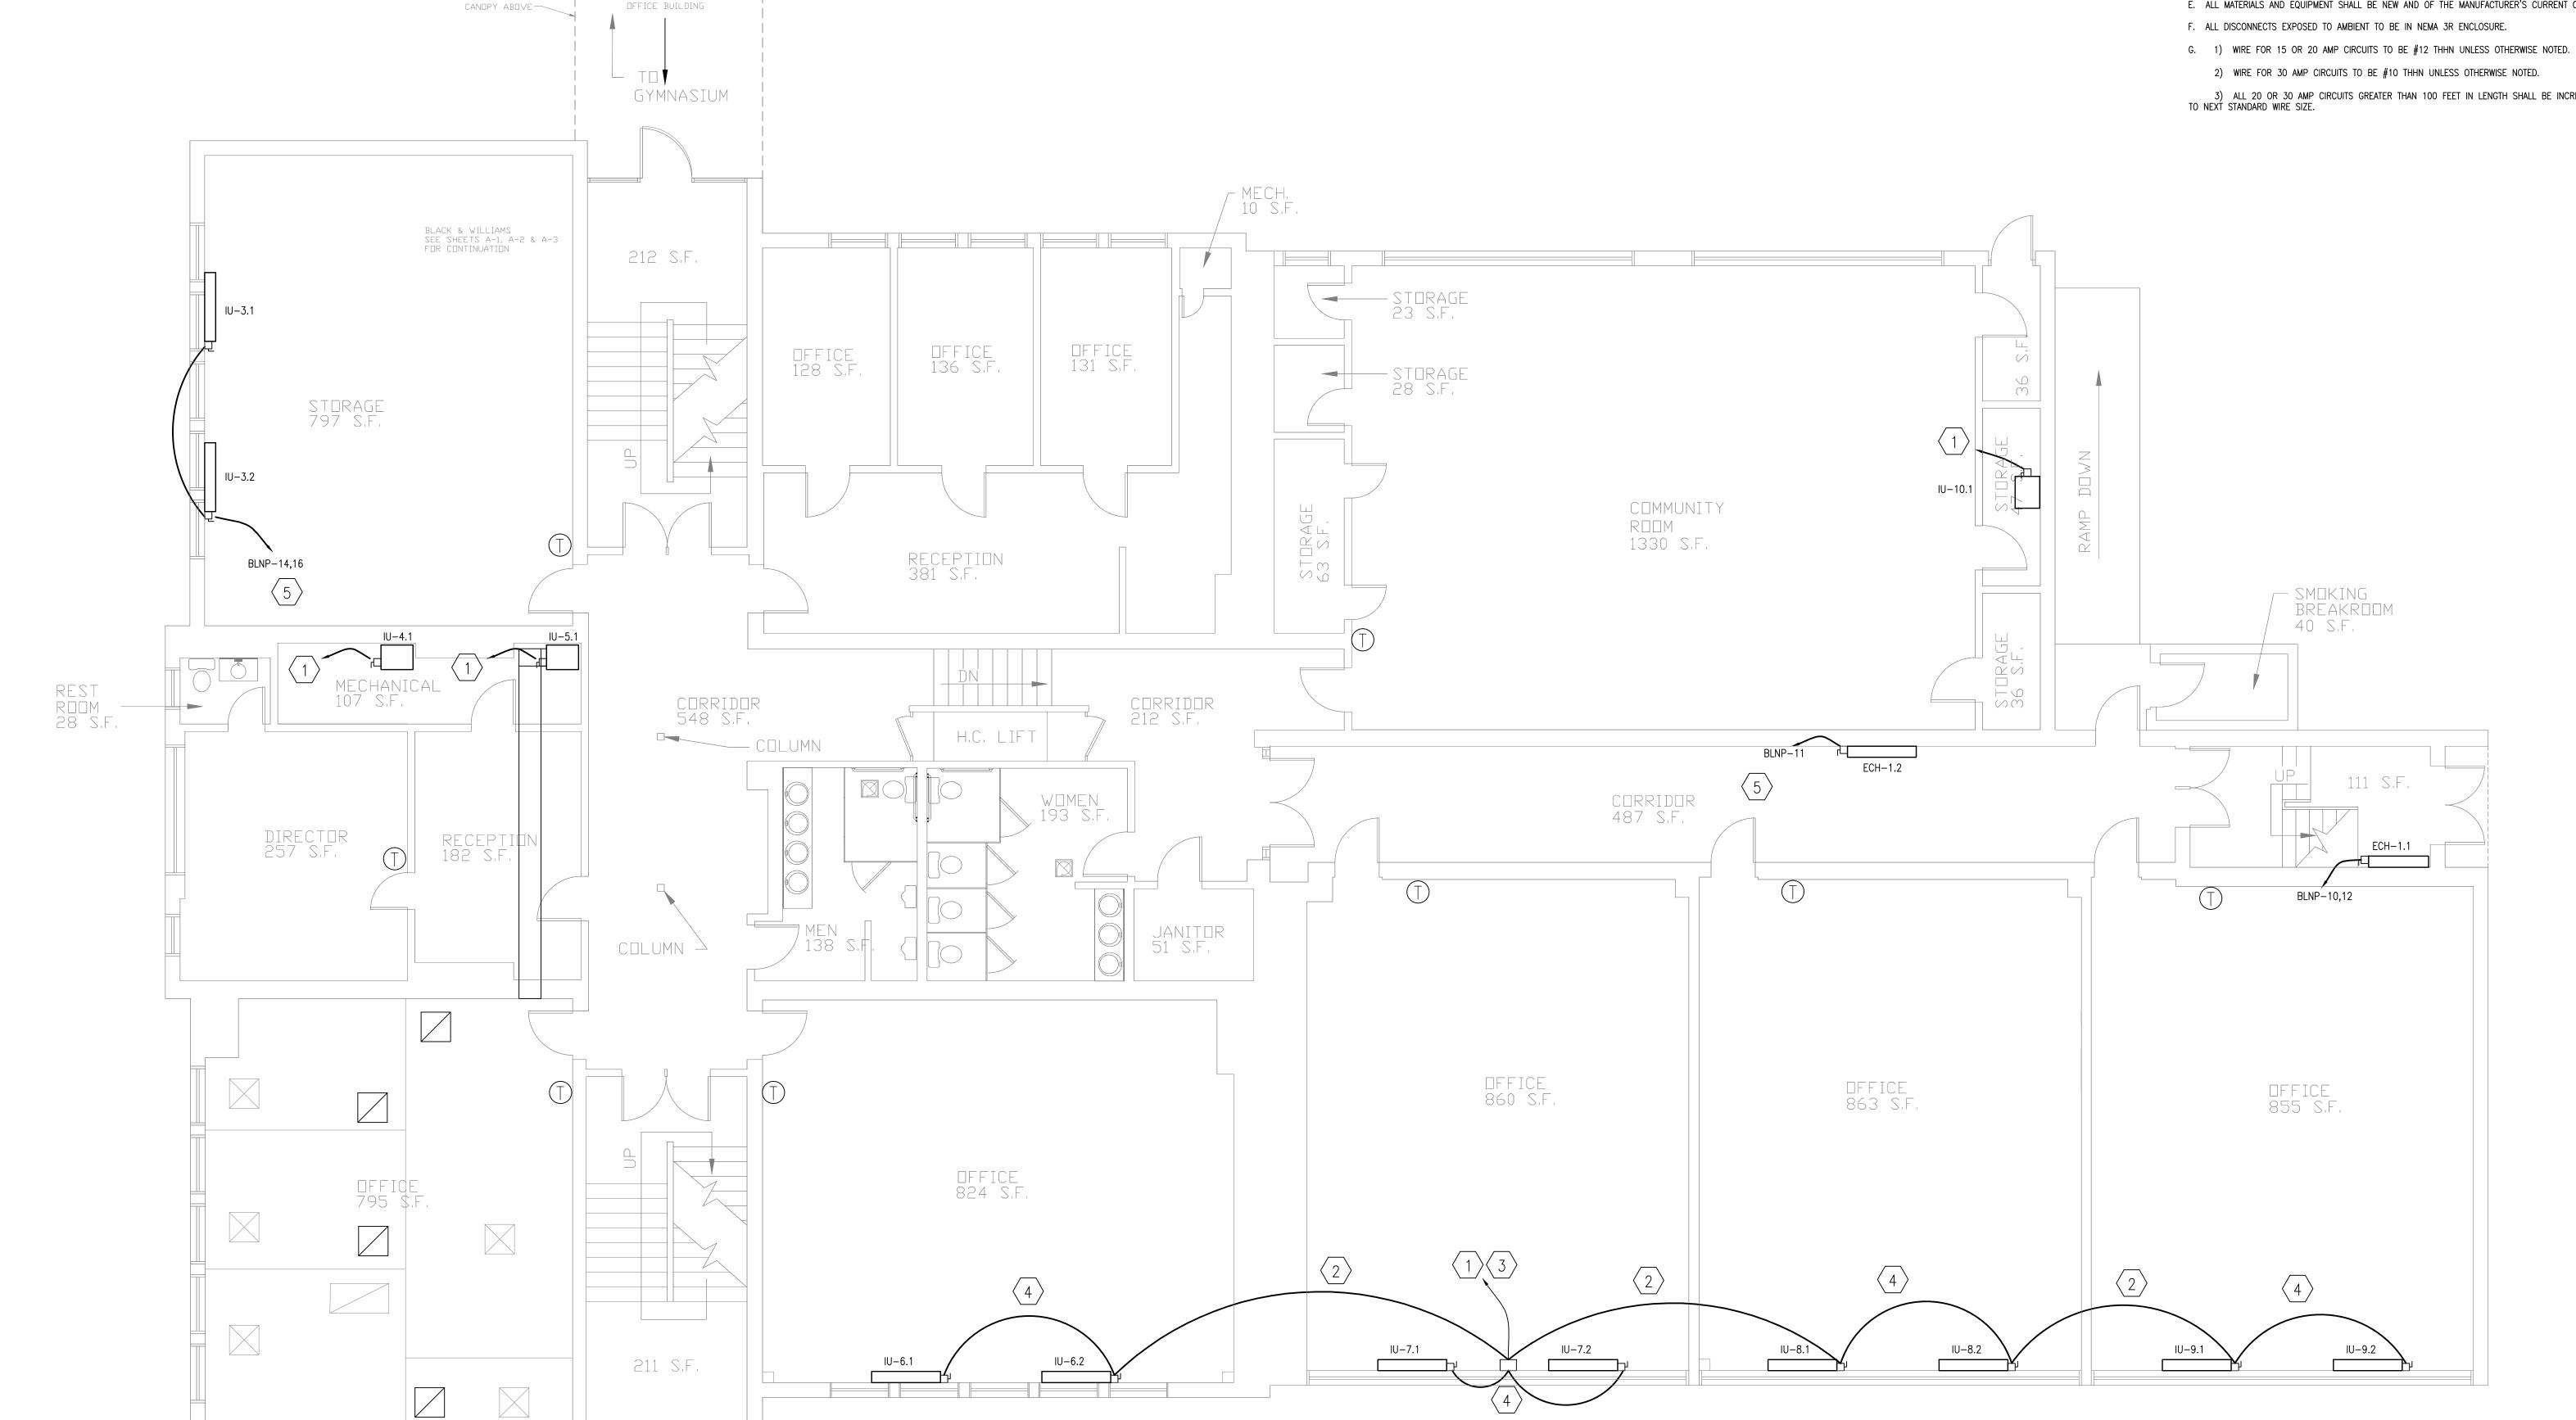
- 2. EXTEND RACEWAY TO ADJOINING ROOM UNITS.
- 3. IDENTIFY PANEL & BREAKER ON JUNCTION BOX W/PERMANENT LABEL.
- 4. COORDINATE DISCONNECT REQUIREMENTS WITH EQUIPMENT MANUFACTURER. REFERENCE MECHANICAL SCHEDULES FOR FACTORY MOUNTED DISCONNECT DEVICES.
- 5. CIRCUIT CONTINUED TO OTHER FLOORS.

General Notes

- A. ELECTRICAL EQUIPMENT AND INSTALLATION SHALL BE IN ACCORDANCE WITH THE LATEST EDITION OF THE NATIONAL ELECTRIC CODE.
- B. PROVIDE LOCAL DISCONNECTING MEANS AS SHOWN AND/OR REQUIRED BY THE N.E.C.
- C. ALL EXPOSED WIRING SHALL BE IN METAL CONDUIT.
- D. ALL MATERIALS SHALL BE UL LISTED AND LABELED AND IN COMPLIANCE WITH THE NATIONAL ELECTRICAL CODE, OTHER APPLICABLE CODES AND STANDARDS.
- E. ALL MATERIALS AND EQUIPMENT SHALL BE NEW AND OF THE MANUFACTURER'S CURRENT OFFERING.

- 2) WIRE FOR 30 AMP CIRCUITS TO BE #10 THHN UNLESS OTHERWISE NOTED.

3) ALL 20 OR 30 AMP CIRCUITS GREATER THAN 100 FEET IN LENGTH SHALL BE INCREASED TO NEXT STANDARD WIRE SIZE.



OFFICE BUILDING

FIRST FLOOR ELECTRICAL PLAN SCALE: 3/16" = 1'-0"







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WORK ORDER NO.

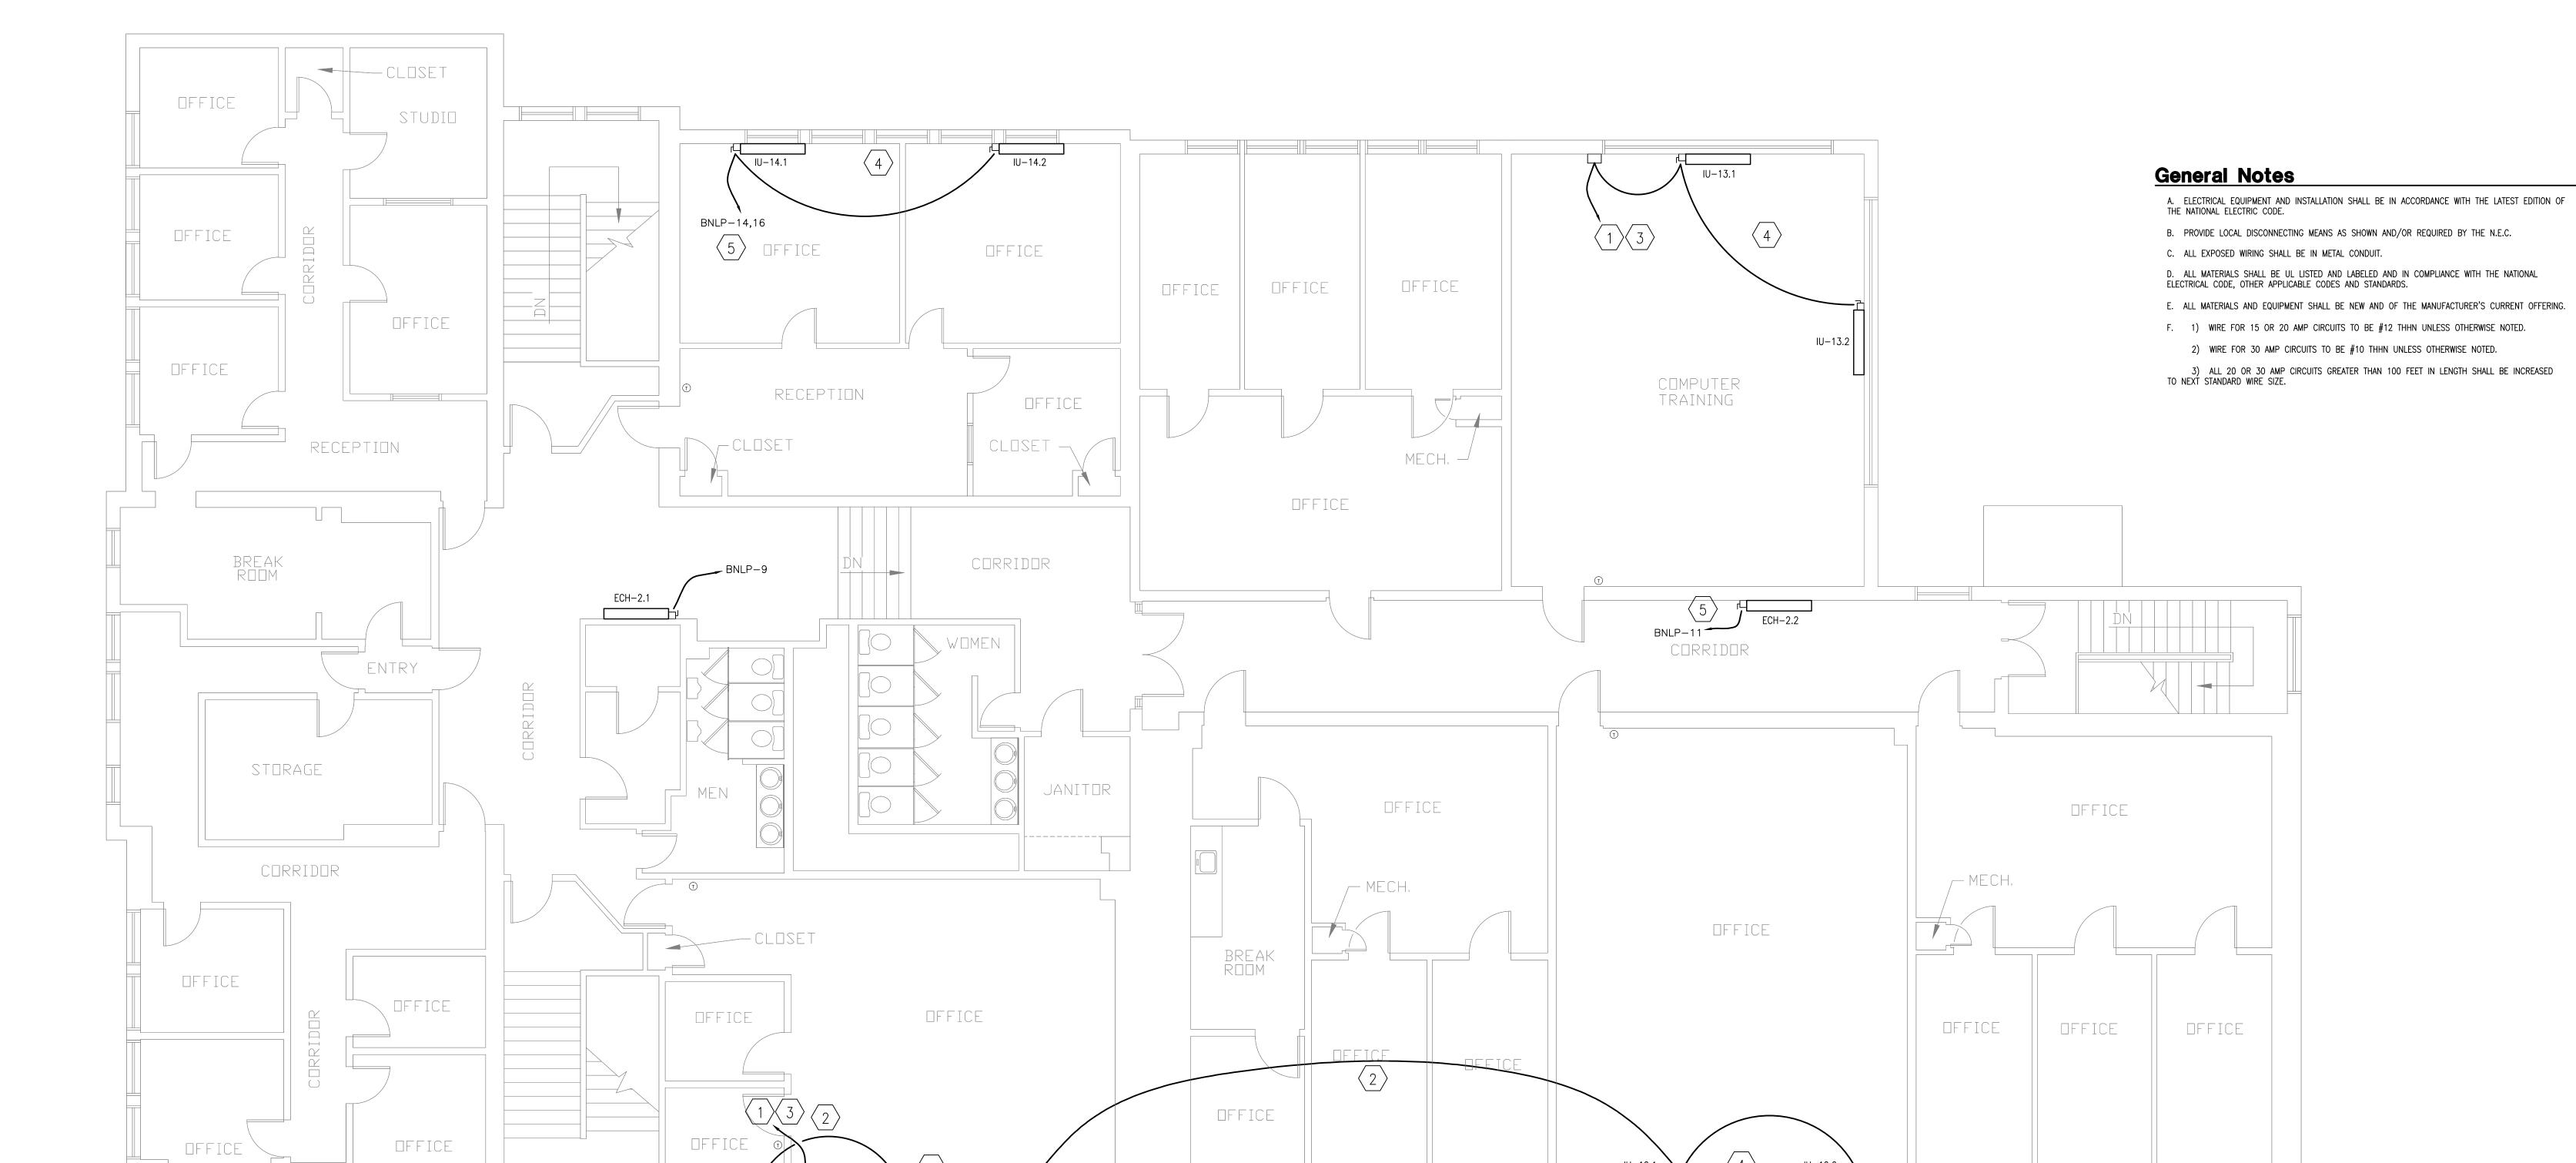- 1. REUSE EXISTING 230V CIRCUIT. VERIFY CIRCUIT IS DEDICATED TO THIS EXISTING OUTLET.
- 2. EXTEND RACEWAY TO ADJOINING ROOM UNITS.
- 3. IDENTIFY PANEL & BREAKER ON JUNCTION BOX W/PERMANENT LABEL.
- 4. COORDINATE DISCONNECT REQUIREMENTS WITH EQUIPMENT MANUFACTURER. REFERENCE MECHANICAL SCHEDULES FOR FACTORY MOUNTED DISCONNECT DEVICES.
- 5. CIRCUIT CONTINUED TO OTHER FLOORS.



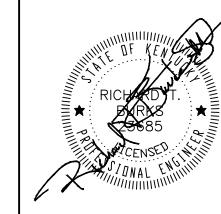SECOND FLOOR ELECTRICAL PLAN SCALE: 3/16" = 1'-0"





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SHEET NO:

Sheet Tagged Notes

COORDINATE DISCONNECT REQUIREMENTS WITH EQUIPMENT MANUFACTURER. REFERENCE MECHANICAL SCHEDULES FOR FACTORY MOUNTED DISCONNECT DEVICES.

2. PROVIDE NEMA 4 ENCLOSURE WITH SUB-METER FOR COMBINED OU-1,2,3 POWER. COORDINATE WITH CONTROLS CONTRACTOR. BASE BID TO BE STAND ALONE METER. ALTERNATE #1 SHALL BE INTEGRATED WITH BUILDING AUTOMATION SYSTEM.

3. 2" EMT CONDUIT EXPOSED TO AMBIENT; ALL WALL PENETRATIONS, JOINTS AND PANEL CONNECTIONS TO BE WATER TIGHT.

4. OU-1; PROVIDE TWO 60A THREE POLE BREAKERS IN EXISTING WEST PANEL. PROVIDE (3) #8 AWG THHN COPPER CONDUCTORS WITH #10 GROUND TO EACH COMPRESSOR CIRCUIT — TWO CIRCUITS PER UNIT.

5. OU-2; PROVIDE TWO 60A THREE POLE BREAKERS IN EXISTING WEST PANEL. PROVIDE (3) #8 AWG THHN COPPER CONDUCTORS WITH #10 GROUND TO EACH COMPRESSOR CIRCUIT — TWO CIRCUITS PER UNIT.

OU-3; PROVIDE ONE 50A THREE POLE BREAKER IN EITHER EXISTING EAST OR WEST PANEL DEPENDING ON SPACE AVAILABILITY. PROVIDE (3) #8 THHN COPPER CONDUCTORS WITH #10 GROUND.
 PROVIDE 20 AMP 120V GFI CONVENIENCE OUTLET IN RAIN TIGHT RECEPTACLE COVER FOR SERVICE OF EQUIPMENT.

General Notes

A. ELECTRICAL EQUIPMENT AND INSTALLATION SHALL BE IN ACCORDANCE WITH THE LATEST EDITION OF THE NATIONAL ELECTRIC CODE.

B. PROVIDE LOCAL DISCONNECTING MEANS AS SHOWN AND/OR REQUIRED BY THE N.E.C.

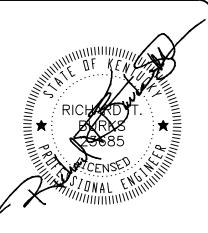
C. ALL EXPOSED WIRING SHALL BE IN METAL CONDUIT.

D. ALL MATERIALS SHALL BE UL LISTED AND LABELED AND IN COMPLIANCE WITH THE NATIONAL ELECTRICAL CODE, OTHER APPLICABLE CODES AND STANDARDS.

E. ALL MATERIALS AND EQUIPMENT SHALL BE NEW AND OF THE MANUFACTURER'S CURRENT OFFERING.F. 1) WIRE FOR 15 OR 20 AMP CIRCUITS TO BE #12 THHN UNLESS OTHERWISE NOTED.

2) WIRE FOR 30 AMP CIRCUITS TO BE #10 THHN UNLESS OTHERWISE NOTED.

3) ALL 20 OR 30 AMP CIRCUITS GREATER THAN 100 FEET IN LENGTH SHALL BE INCREASED TO NEXT STANDARD WIRE SIZE.



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Government

xington Fayette Urban County Go Black and Williams Adult Services Division 498 Georgetown Street

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1. CONDUCTOR LENGTH SHALL NOT EXCEED 25 FEET.

2. TAP BUS OF EXISTING 800A SUB PANEL.


3. PANEL LABELING IS BASED ON EXISTING LABELING. NO VERIFICATION OF CIRCUITS HAS BEEN CONDUCTED AND THERE IS NO REPRESENTATION AS TO THE PANEL LABELING ACCURACY. VERIFY ALL CIRCUITS ARE DISCONNECTED PRIOR TO SERVICING.

4. REVISE PANEL SCHEDULE AND LABEL CIRCUITS IN PANEL INSERT AND ON RECORD DRAWING.


5. REFERENCE PANEL SCHEDULE FOR ADDITIONAL CIRCUITS & WIRE/CONDUIT SCHEDULE NOTES FOR WIRE SIZING INFORMATION. ALL CONDUITS TO BE SIZED PER LATEST VERSION OF NATIONAL ELECTRIC CODE.

General Notes

VOLTS/PHA 120/240/		PANEL S		MAIN TYPE & SIZE: 400 A MB			CABINET: NEMA 1 SURFACE		MIN SCC: FED FROM: 42kA EXISTING SU		B PANEL
CIRCUIT NO.	AREA SERVED	TRIP AMPS	NO. POLES	A Pi	HASE LOAD	VA C	NO. POLES	TRIP AMPS	AREA :	SERVED	CIRCUI NO.
	DAGENENT HEATERS			3984	В				0011711 50	(50.115.1750	
1, 3	BASEMENT HEATERS ECH-0.4, 0.6	20	2	4008			2	20		ÆR HEATER -0.3	2, 4
					3984						
					4008		_				
				3000	1000						
5	STORAGE HEATERS ECH-0.1, 0.2	30	1	4008			_ 2	20		'ER HEATER -0.5	6, 8
				+000	1200						
7	HVAC SYSTEM CONTROL PANEL	20	1				_				
					4008						
9	CORRIDOR HEATER ECH-2.1	20	1	1500			_ 2	20		ER HEATER -1.1	10, 1
				4008							
11	CORRIDOR HEATERS ECH-1.2, 2.2	30	1		3000		_				
	LOII 1.2, 2.2				4008						
13, 15	VRV CONTROL VALVES	20	2	336			_ 2	20	INDOOF IU-1.1, 1.2,	R UNITS 2.1, 3.1, 3.2,	14, 1
	BS-1 THRU 14		_	1008					14.1,	2.1, 3.1, 3.2, 14.2	, ,
					336						
					1008						
17 10	CDARE	70						00	2	A D.E.	4.0
17, 19	SPARE	30	2	0			1	20	SP,	ARE	18
					0		1	20	SPA	ARE	20
				0							
21	SPACE		1				1		SPA	ACE	22
					0						
23	SPACE		1				1		SPA	ACE	23
25	SPACE		1				1		SPA	ACE	26
27	SPACE		1				1		SPA	ACE	28
29	SPACE		1				_ 1		SPA	ACE	30
31	SPACE		1				_ 1		SPA	ACE	32
33	SPACE		1				_ 1		SP,	ACE	34
35	SPACE		1				_ 1		SP	ACE	36
- -	22								51,7		
37	SPACE		1	0			1		Su Su	ACE	38
J/	JFACE) 	NOL	30
70	00105				0					AOF	
39	SPACE		1				1		SP/	ACE	40
				0							
41	SPACE		1	0			1		SP,	4CE	42
	CONNECTED LOAD	<u> </u>		21852	21552	0		<u> </u>	0.0 KV	Δ	

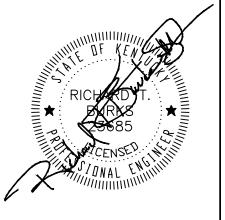
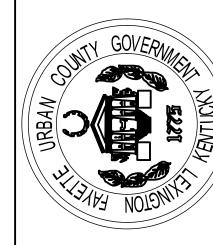
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